

- PERFORATED METAL SOFFIT. RANGE HOOD PB 8'-0" CENTERED ON U/S OF UPPER CABINET - CENTERED ON SINK BELOW. MOUNT 3'-6" AFF. MOUNT TO U/S OF STAIRWAY -LEADING TO THE UPPER FLOOR. PB 8'-0" APPROX. 11'-0" AFF — CENTERED ON SINK BELOW. PB 8'-0" FGGB 8'-0" FGGB 8'-0" 02 MAIN FLOOR REFLECTED CEILING PLAN A2-01 SCALE: 1/4" = 1'-0"

TABLE BELOW.

01 MAIN FLOOR PLAN A2-01 SCALE: 1/4" = 1'-0"

LIGHTING LEGEND

1. For typical legend, notes and abbreviations, refer to drawing A0-01
2. Do not install ceiling finishes until work above ceiling has been inspected by Consultant.

PB Indicates ceiling height and finish above the floor below it OR u/s of ceiling.

Indicates mechanical exhaust fan. Read in conjunction with Mechanical drawings (not in scope).

Indicates 12" (450mm) surface mounted LED light for wet areas.

Indicates 18" (450mm) surface mounted LED light.

Indicates 2' wall mounted LED sconce w/ diffuser. Mount 6'-6" AFF unless otherwise noted.

Indicates 24" LED strip light mounted to underside of cabinet.

SMOKE

96 BARONS AVENUE SOUTH, HAMILTON, ONTARIO, L8K 2Y6 807-633-0496 | smokearchitecture@gmail.com

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2 2020 JAN 16 ISSUED FOR 99% REVIEW
1 2019 DEC 15 ISSUED FOR DRAFT REVIEW

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PROJECT TITLE

National Research
Council of Canada:
A Path To Healthy Housing

Bunibonibee Cree Nation, Oxford House 24, Manitoba

N IPAIT

David T Fortin Architect INC.

DRAWING TITLE

MAIN FLOOR PLAN +
MAIN FLOOR
REFLECTED CEILING
PLAN


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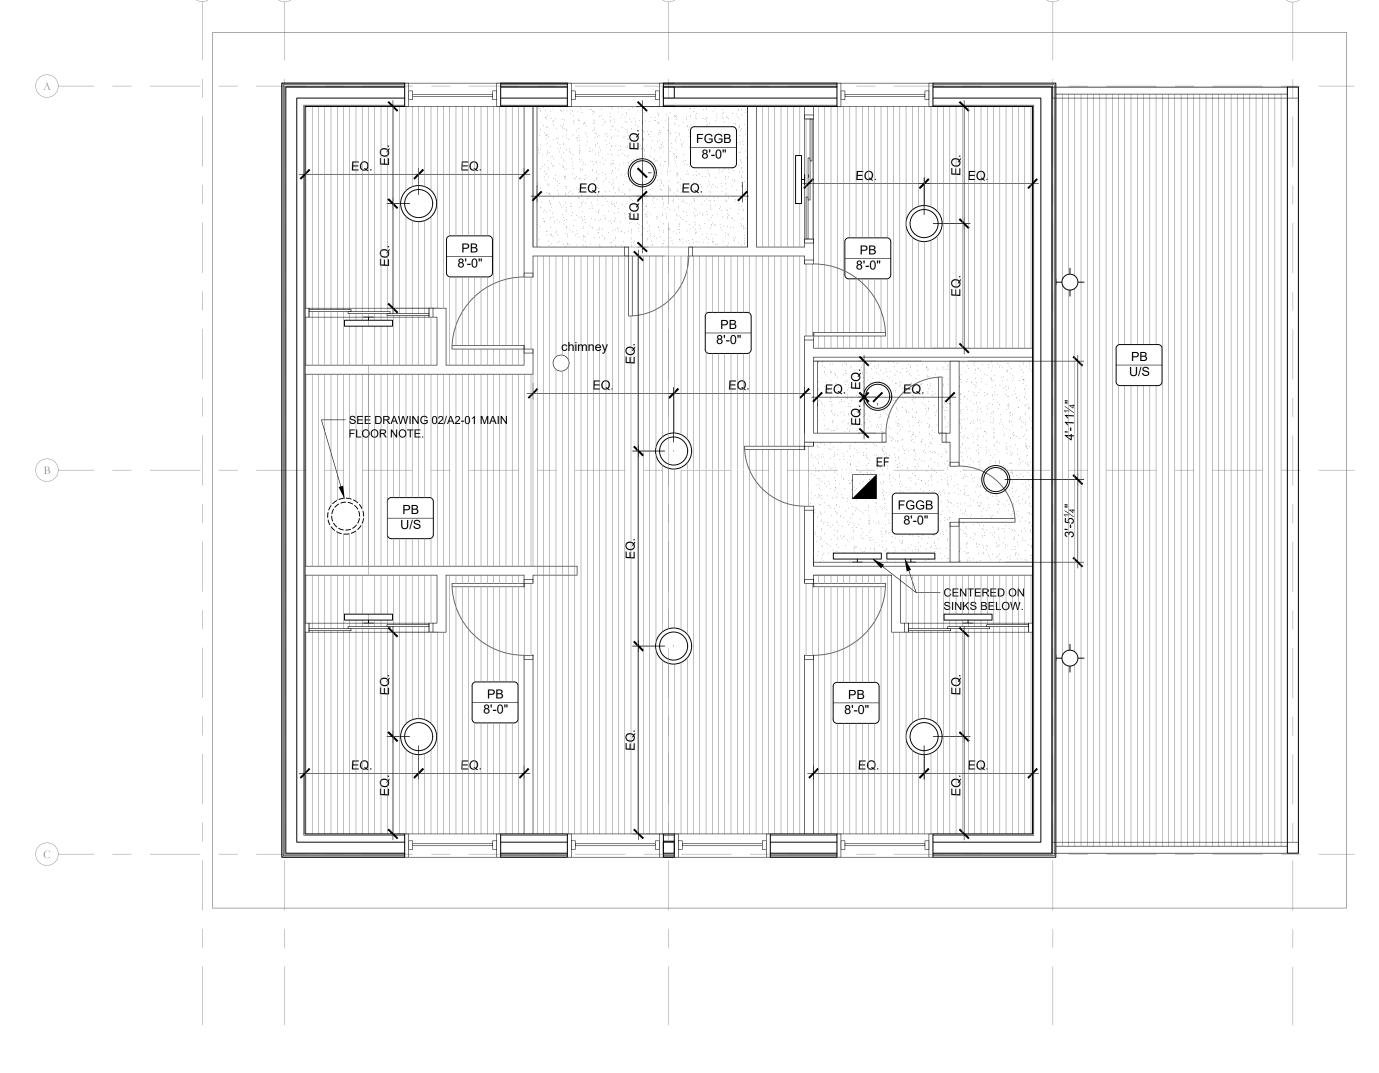
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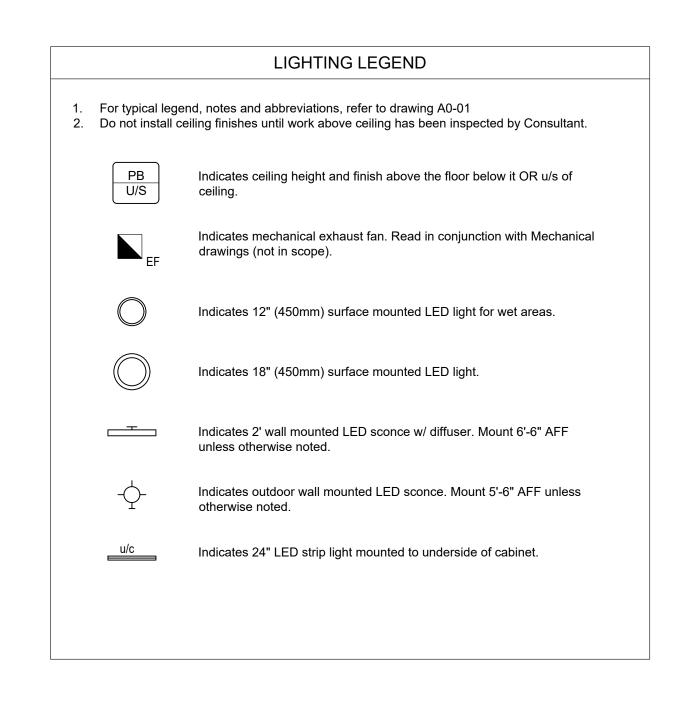
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01 SECOND FLOOR PLAN A2-02 SCALE: 1/4" = 1'-0"



02 SECOND FLOOR REFLECTED CEILING PLAN
A2-02 SCALE: 1/4" = 1'-0"



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PROJECT TITLE

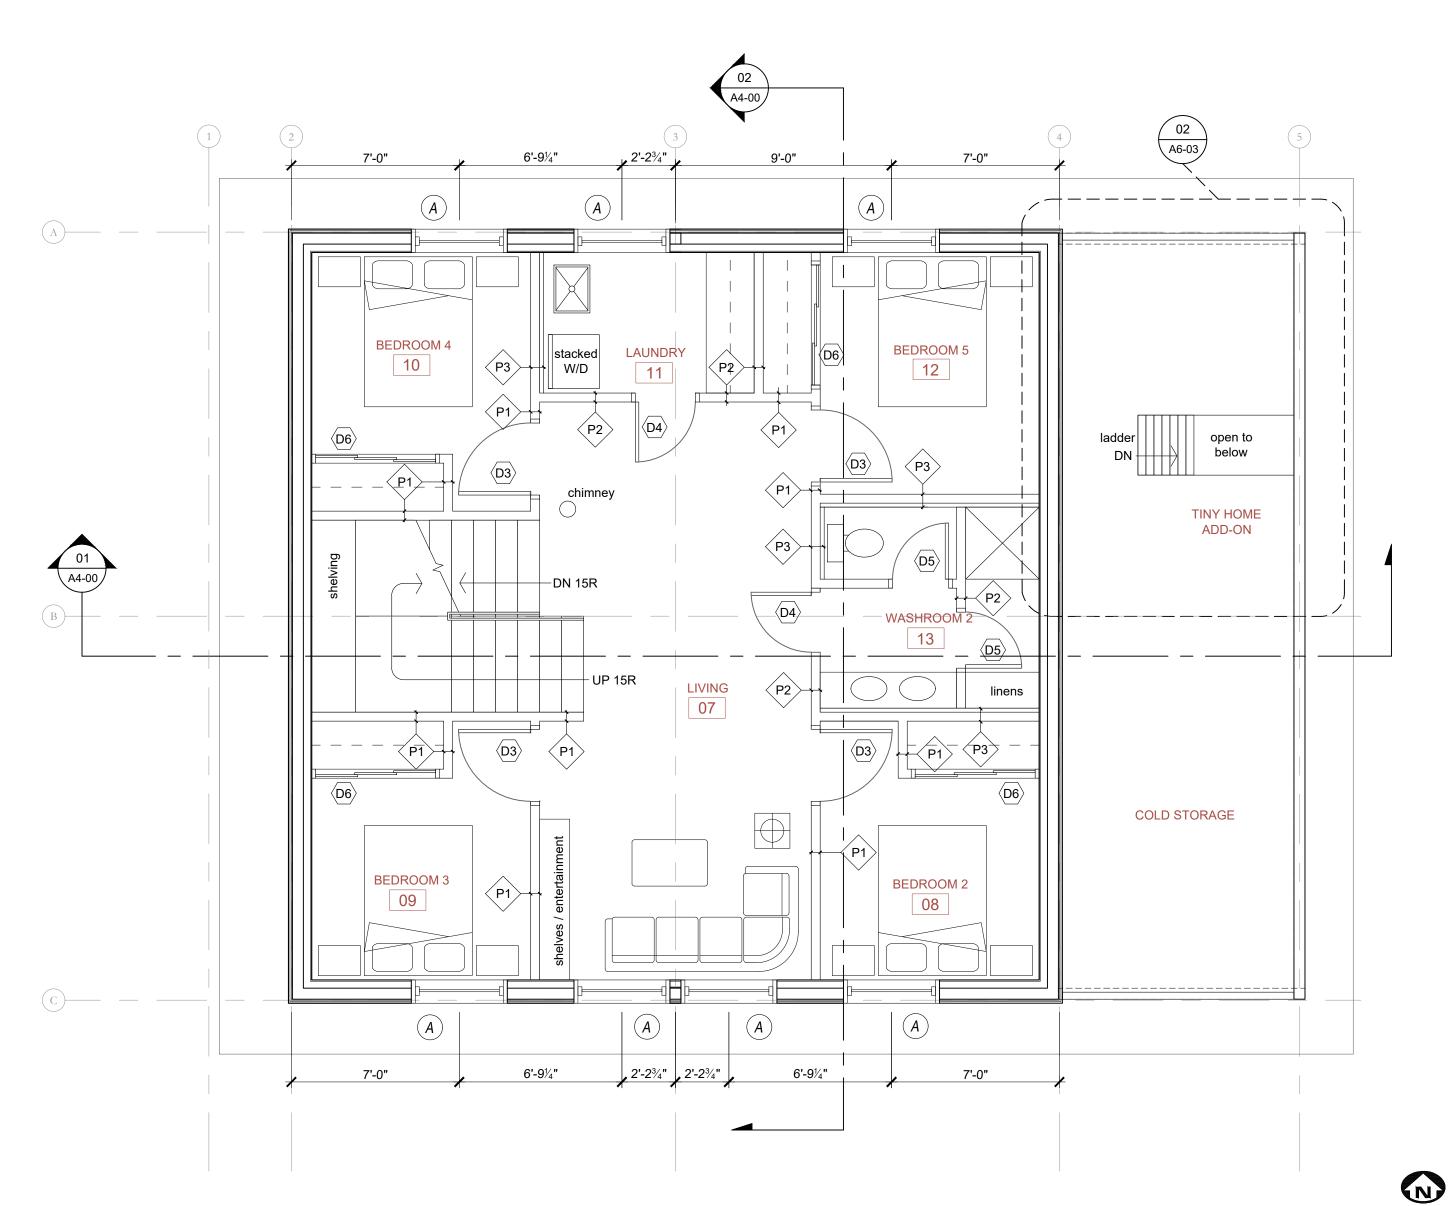National Research
Council of Canada:
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LOCATIONBunibonibee Cree Nation, Oxford House 24, Manitoba

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David T Fortin Architect INC.

DRAWING TITLE

SECOND FLOOR PLAN + SECOND FLOOR REFLECTED CEILING

PLAN


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01 UPPER FLOOR PLAN A2-03 SCALE: 1/4" = 1'-0" MOUNT FACATT

WORT FACATT

WORT

02 UPPER FLOOR REFLECTED CEILING PLAN
A2-03 SCALE: 1/4" = 1'-0"

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Indicates 24" LED strip light mounted to underside of cabinet.
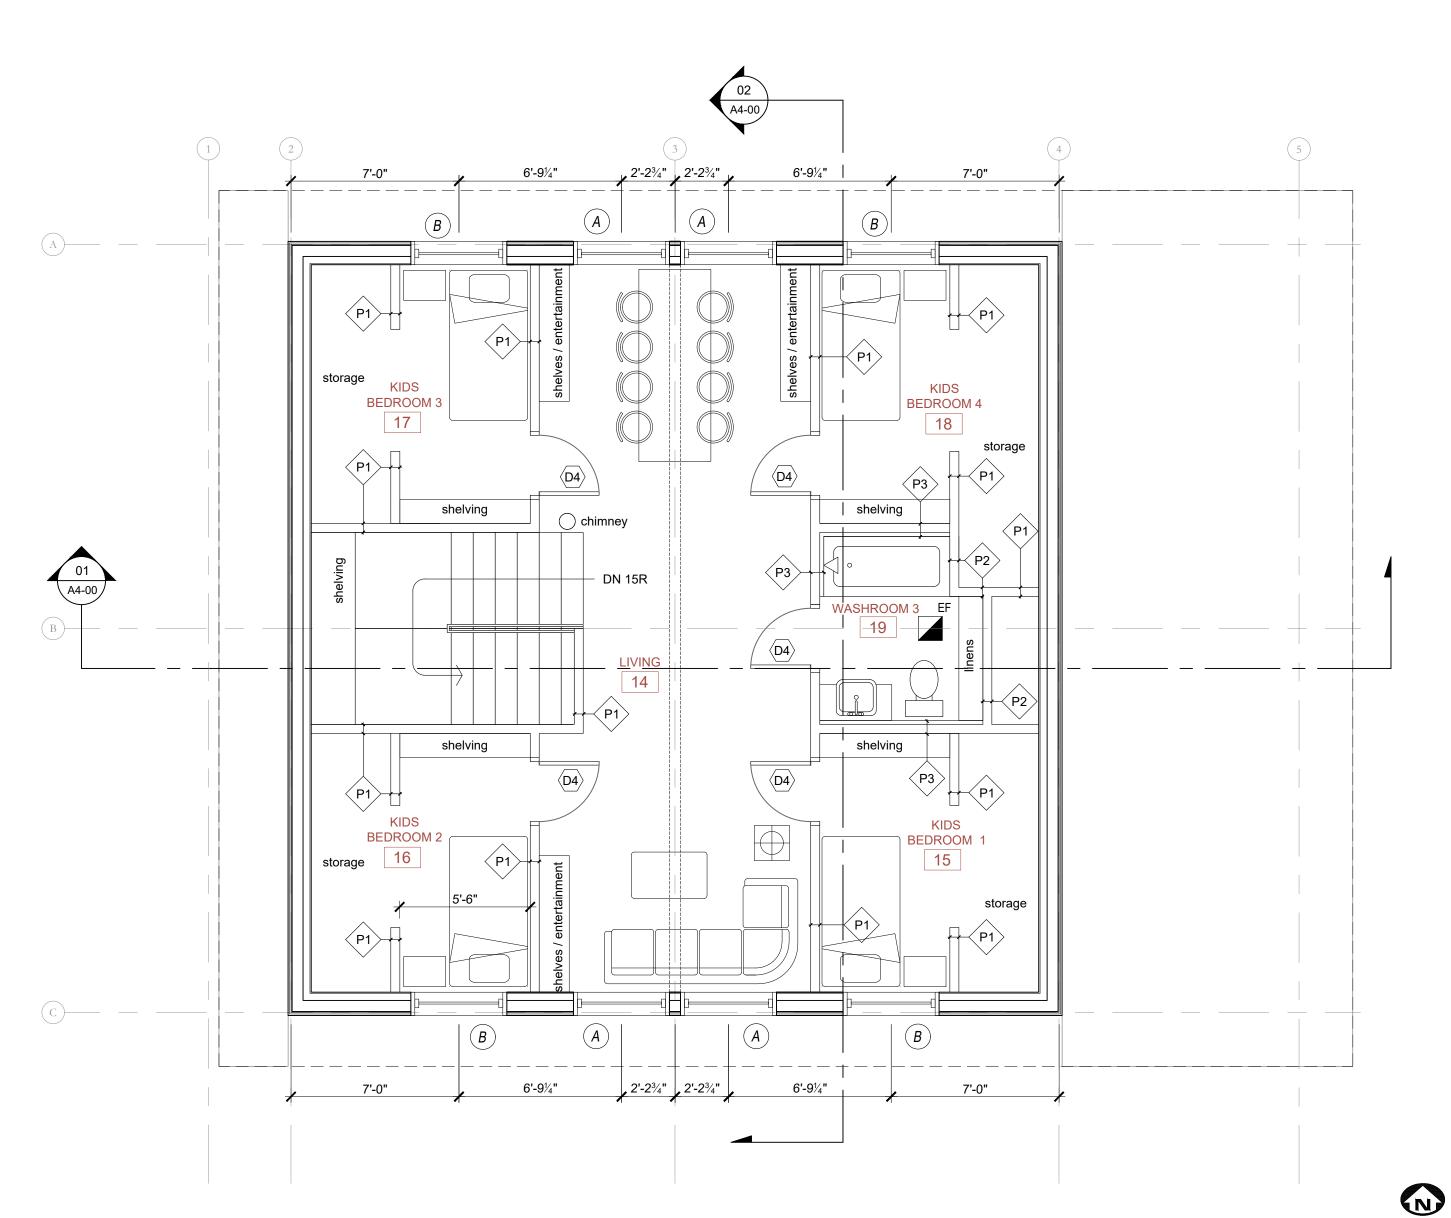
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Council of Canada:
A Path To Healthy Housing

LOCATIONBunibonibee Cree Nation, Oxford House 24, Manitoba

CLIENT
David T Fortin Architect INC.

DRAWING TITLE

UPPER FLOOR PLAN + UPPER FLOOR REFLECTED CEILING PLAN

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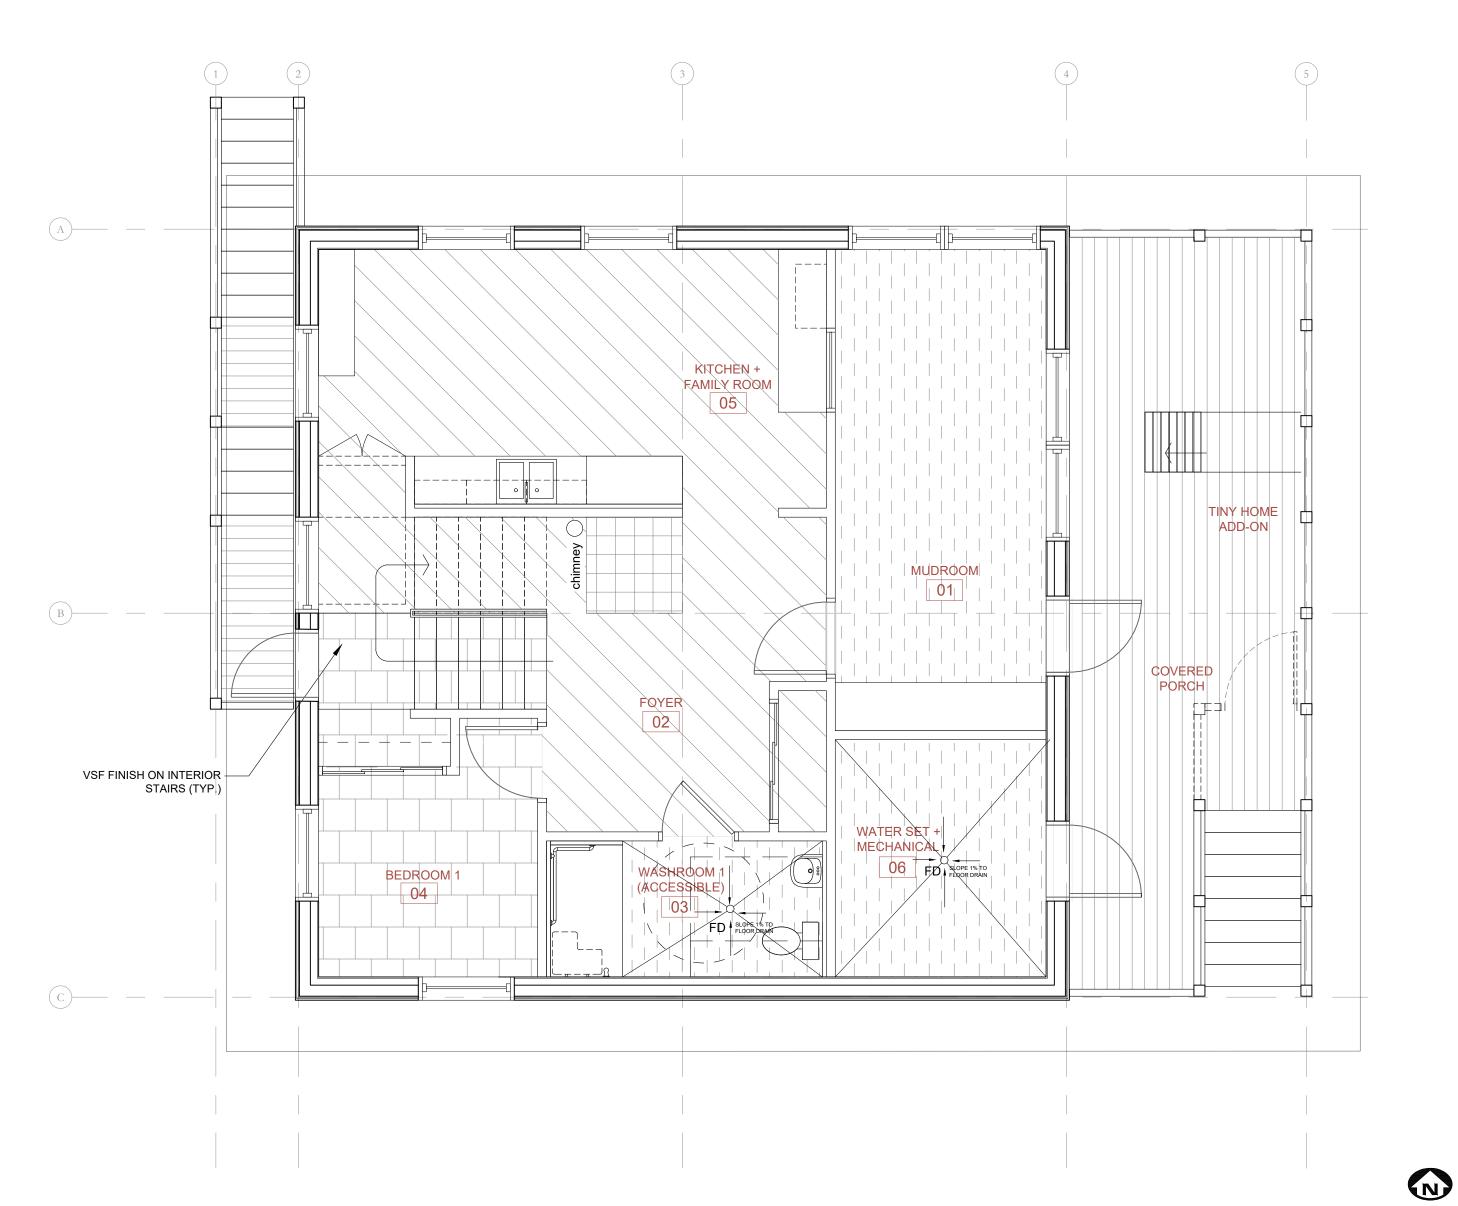
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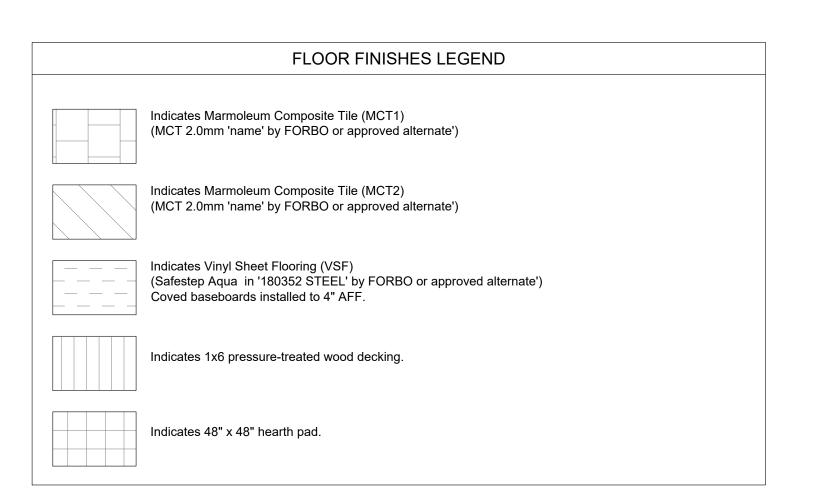
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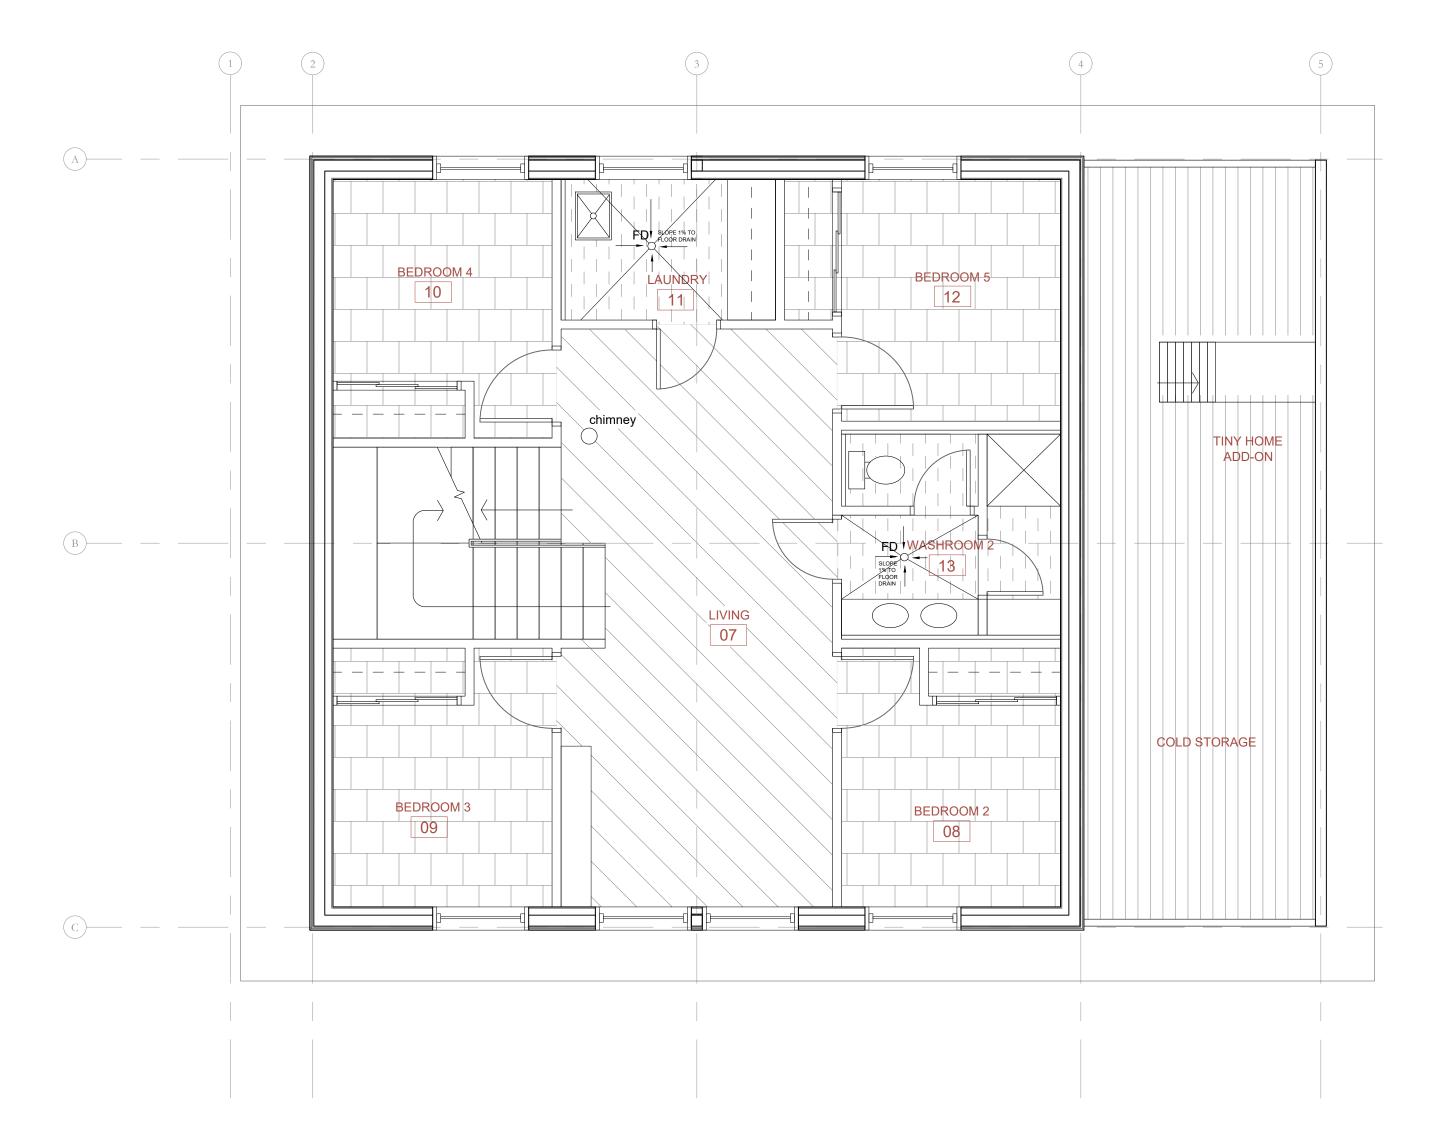
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01 MAIN FLOOR FINISHES PLAN
A2-04 SCALE: 1/4" = 1'-0"





02 SECOND FLOOR FINISHES PLAN A2-01 SCALE: 1/4" = 1'-0"

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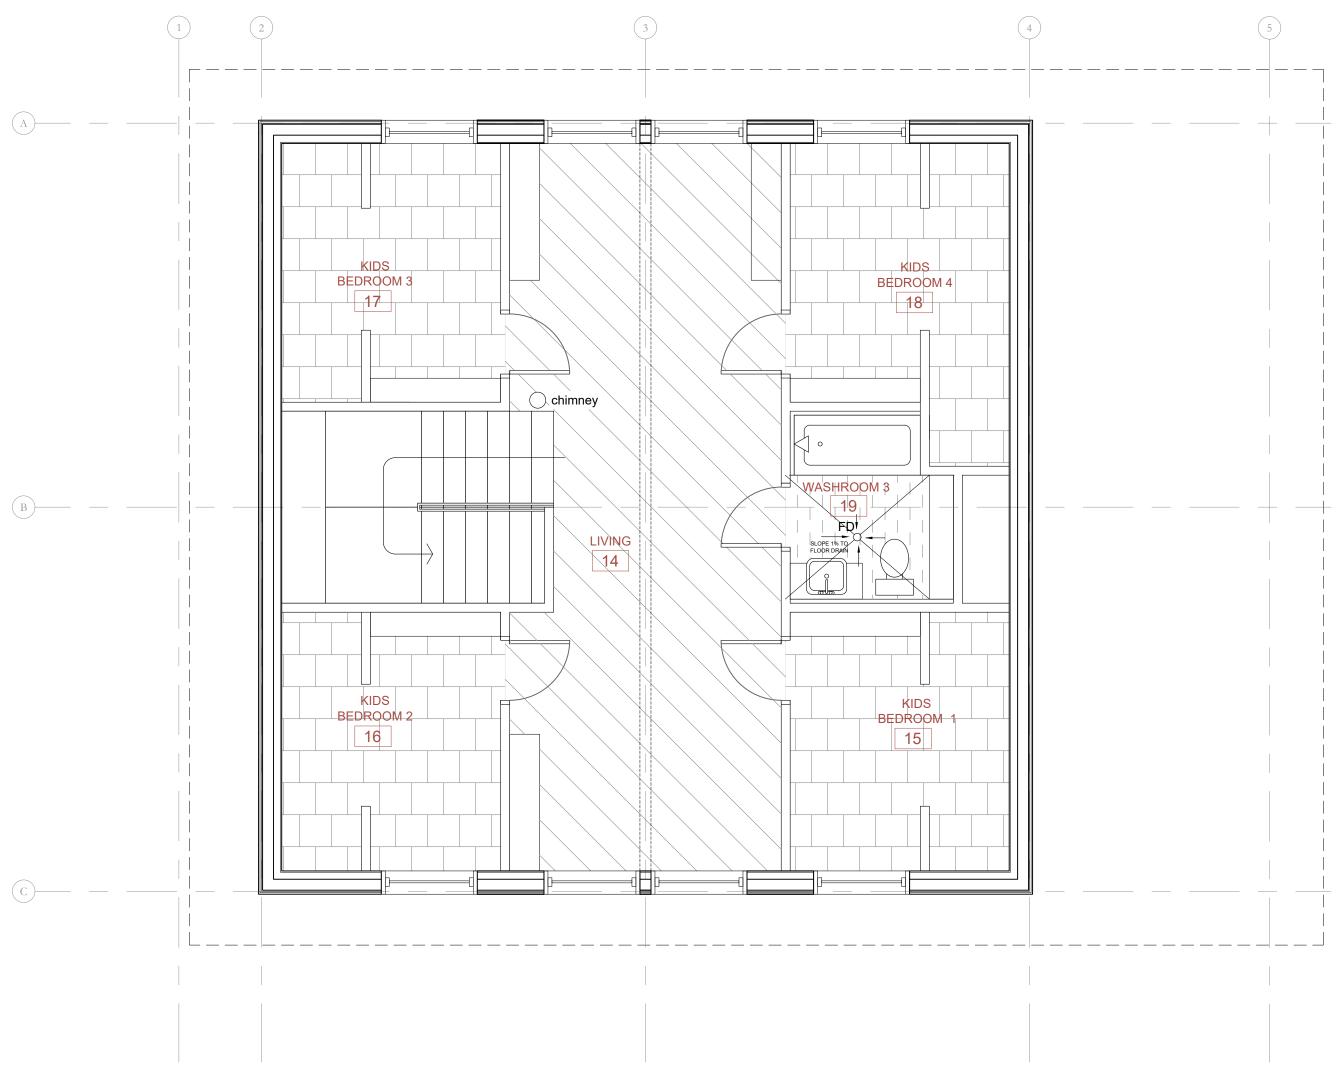
MAIN FLOOR PLAN +
MAIN FLOOR
REFLECTED CEILING
PLAN

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			F	ROOM	FINIS	H SCH	HEDUL	.E	
ROOM #	ROOM NAME	FLOOR FINISH	BASE	N	WA E	LLS S	W	CEILING FINISH	REMARKS
01	MUDROOM	VSF	IWB	PT	PT	PT	PT	РВ	SEE SPEC. FOR PAINT TYPES
02	FOYER	MCT1	MDF	PT	PT	PT	PT	РВ	SEE SPEC. FOR PAINT TYPES
03	WASHROOM 1	VSF	IWB	PT	PT	PT	PT	PT	SEE SPEC. FOR PAINT TYPES
04	BEDROOM 1	MCT2	MDF	PT	PT	PT	PT	РВ	SEE SPEC. FOR PAINT TYPES
05	KITCHEN + FAMILY	MCT1	MDF	PT	PT	PT	PT	РВ	SEE SPEC. FOR PAINT TYPES
06	WATER SET +MECH	VSF	IWB	PT	PT	PT	PT	PT	SEE SPEC. FOR PAINT TYPES
07	LIVING	MCT1	MDF	PT	PT	PT	PT	РВ	SEE SPEC. FOR PAINT TYPES
08	BEDROOM 2	МСТ2	MDF	PT	PT	PT	PT	РВ	SEE SPEC. FOR PAINT TYPES
09	BEDROOM 3	MCT2	MDF	PT	PT	PT	PT	РВ	SEE SPEC. FOR PAINT TYPES
10	BEDROOM 4	MCT2	MDF	PT	PT	PT	PT	РВ	SEE SPEC. FOR PAINT TYPES
11	LAUNDRY	VSF	IWB	PT	PT	PT	PT	PT	SEE SPEC. FOR PAINT TYPES
12	BEDROOM 5	МСТ2	MDF	PT	PT	PT	PT	РВ	SEE SPEC. FOR PAINT TYPES
13	WASHROOM 2	VSF	IWB	PT	PT	PT	PT	PT	SEE SPEC. FOR PAINT TYPES
14	LIVING	MCT1	MDF	PT	PT	PT	PT	РВ	SEE SPEC. FOR PAINT TYPES
15	KIDS BEDROOM 1	MCT2	MDF	PT	PT	PT	PT	РВ	SEE SPEC. FOR PAINT TYPES
16	KIDS BEDROOM 2	MCT2	MDF	PT	PT	PT	PT	РВ	SEE SPEC. FOR PAINT TYPES
17	KIDS BEDROOM 3	MCT2	MDF	PT	PT	PT	PT	РВ	SEE SPEC. FOR PAINT TYPES
18	KIDS BEDROOM 4	MCT2	MDF	PT	PT	PT	PT	РВ	SEE SPEC. FOR PAINT TYPES
19	WASHROOM 3	VSF	IWB	PT	PT	PT	PT	PT	SEE SPEC. FOR PAINT TYPES

ABBREVIATIONS & SPECIFICATIONS

PT Painted Gypsum Board ('satin' finish for wet areas, 'eggshell' for everywhere else)

VSE Vipul Shoot Flooring

VSF Vinyl Sheet Flooring (see Floor Finishes Legend Below)

IWB Vinyl Integrated Wall Base

Medium Density Fibreboard Wall Base (paint with latex enamel w/ semi-gloss finish)

3/8" T + G Pineboard

Vinyl Integrated Wall Base (see Floor Finishes Legend Below)

MCT Marmoleum Composite Tile (see Floor Finishes Legend Below)

01 UPPER FLOOR FINISHES PLAN
A2-03 SCALE: 1/4" = 1'-0"

FLOOR FINISHES LEGEND					
Indicates Marmoleum Composite Tile (MCT1) (MCT 2.0mm 'name' by FORBO or approved alternate')					
Indicates Marmoleum Composite Tile (MCT2) (MCT 2.0mm 'name' by FORBO or approved alternate')					
Indicates Vinyl Sheet Flooring (VSF) (Safestep Aqua in '180352 STEEL' by FORBO or approved alternate') Coved baseboards installed to 4" AFF.					
Indicates 1x6 pressure-treated wood decking.					
Indicates 48" x 48" hearth pad.					

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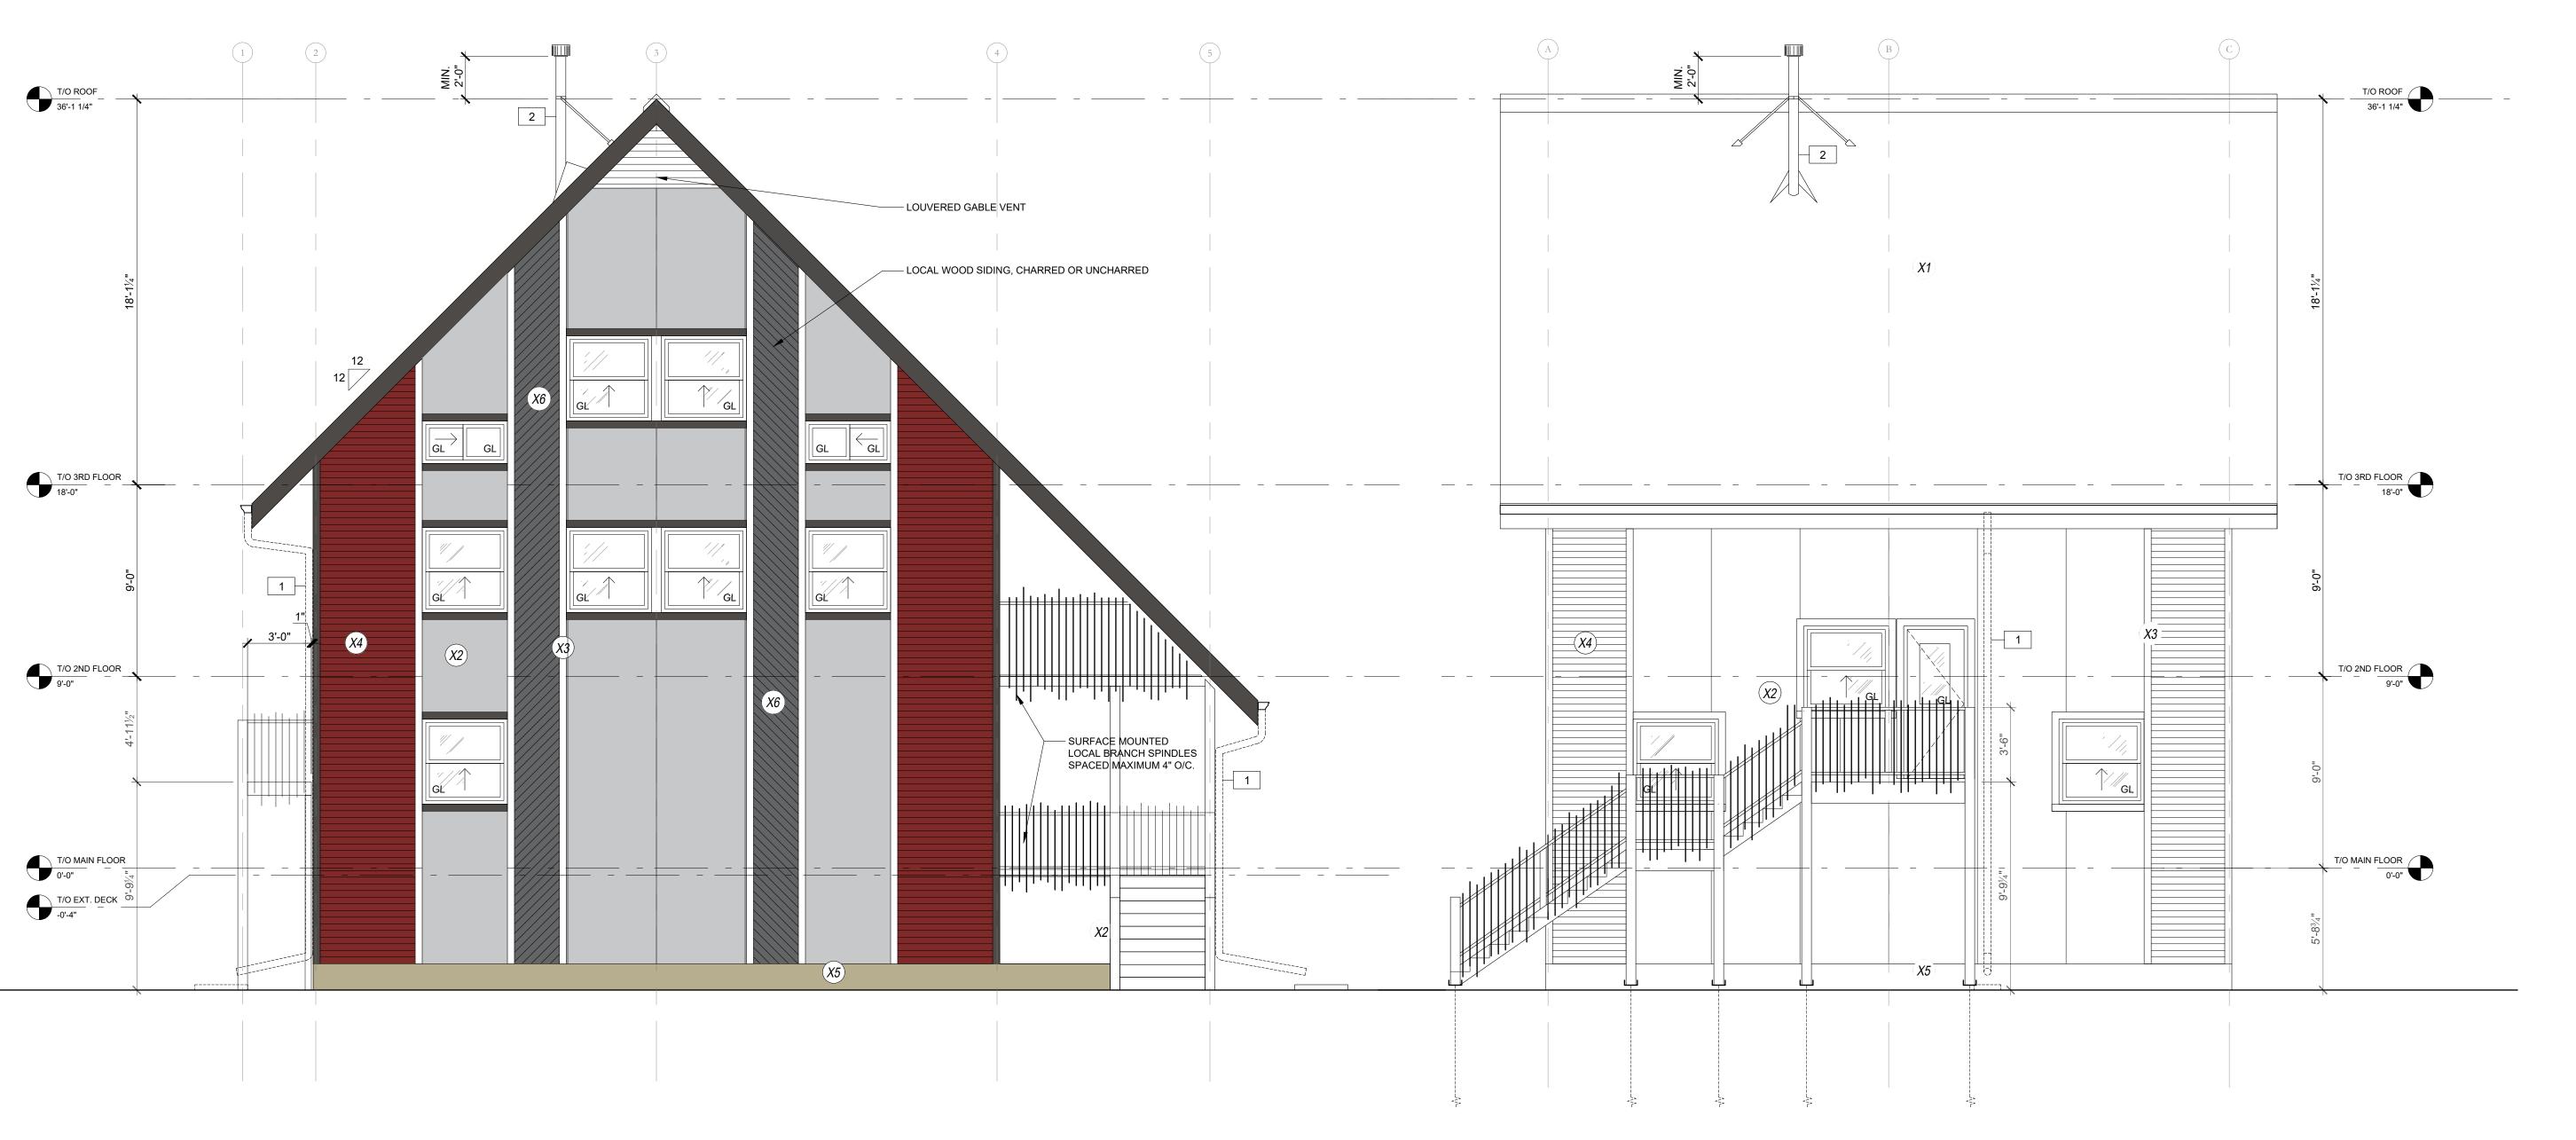
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DRAWING TITLE

UPPER FLOOR FINISHES PLAN + ROOM FINISH SCHEDULE

DRAWN LR	APPROVED ES	DRAWING NO.
SCALE AS NOTED	DATE ISSUED APRIL 14, 2020	A2-05
PROJECT NUMBER 1905	REVISION NO. R-0	



01 NORTH EXTERIOR ELEVATION
A3-00 SCALE: 1/4" = 1'-0"

EXTERIOR FINISHES LEGEND

02 EAST EXTERIOR ELEVATION
A3-00 SCALE: 1/4" = 1'-0"

Refer to installation instructions by manufacturer. All exposed wood substrate must be primed and painted to match product's surface colour. Paint all exposed metal surfaces on roof (flashing, vents, etc.) with matching roof accessory paint. Indicates 16" Steel Roofing panels with concealed fasteners (Steel Profile Snap-Lok 16" in "REGENT GREY QC 8730" by Westman Steel or approved alternate) Indicates 7/16" pre-finished panel, borate-impregnated wood fibre substrate with resin binding. 4' x 8' No-Groove Textured Strand Panel Siding in 'Mist Grey' by LP Smartside. Indicates 3/8" x 5 1/2" pre-finished lap siding, borate-impregnated wood fibre substrate with resin binding. (13 mm x 140 mm) Exterior Wood Trim in 'Commercial Brown' by KAYCAN Naturetech. Indicates 3/8" x 6" pre-finished lap siding, borate-impregnated wood fibre substrate with resin binding. WTB346121340 (13 mm x 140mm) ExteriorWood Trim in 'Red Wine' or 'Country Red' by KAYCAN Naturetech. Indicates 3/4"" x 48" x 96" cement board rated for ground contact.

					WINDOW	SCHEDULE			
QTY	NO.	WIDTH	HEIGHT	SILL HEIGHT	FRAME MATERIAL	GL TYPE	REMARKS		
8	Α	4'-0"	4'-0"	3'-0"	EXTRUDED FIBREGLASS	TRIPLE PANE MIN. OVERALL THICKNESS 37MM	Single-hung operable windows. Prefinished, extruded fibreglass frames. Laminated glass for exterior window panes, low-e coating, inert gas fill, framed in screen insert.		
11	В	4'-0"	3'-0"	5'-0"	EXTRUDED FIBREGLASS	TRIPLE PANE MIN. OVERALL THICKNESS 37MM	Sliding operable windows. Prefinished, extruded fibreglass frames. Laminated glass for exterior window panes, low-e coating, inert gas fill, framed insect screen insert for sliding windows.		
NOTE	ES: FRAITRACTO	ME TO RECIPIENT TO CONF	FIRM R.O. PRIOF	GL 0"		TRIPLE PANE I NOTES: APPLY LOW PANE 1 - TEMPEREI PANE 2 - ANNEALED PANE 3 - LAMINATE	D GLASS D GLASS		

EXTERIOR ELEVATION NOTES	
NOTE 1	
Downspout c/w 48" kick to precast concrete splashpad.	
NOTE 2	
Chimney c/w louvered vent cap, snow defelector and metal strap roof anchors. Extend chimney pipe to minimum 24" higher	

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National Research
Council of Canada:
A Path To Healthy Housing

LOCATIONBunibonibee Cree Nation, Oxford House 24, Manitoba

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David T Fortin Architect INC.

DRAWING TITLE

NORTH AND EAST EXTERIOR ELEVATIONS

DRAWN LR	APPROVED ES	DRAWING NO.
SCALE AS NOTED	DATE ISSUED APRIL 14, 2020	A3-00
PROJECT NUMBER 1905	REVISION NO. R-0	_



SOUTH EXTERIOR ELEVATION A3-01 SCALE: 1/4" = 1'-0"

EXTERIOR FINISHES LEGEND

2. All exposed wood substrate must be primed and painted to match product's

1. Refer to installation instructions by manufacturer.

02 WEST EXTERIOR ELEVATION A3-01 SCALE: 1/4" = 1'-0"

3. Paint	ce colour. all exposed metal surfaces on roof (flashing, vents, etc.) with matching ccessory paint.
(X1)	Indicates 16" Steel Roofing panels with concealed fasteners (Steel Profile Snap-Lok 16" in "REGENT GREY QC 8730" by Westman Steel or approved alternate)
(X2)	Indicates 7/16" pre-finished panel, borate-impregnated wood fibre substrate with resin binding. 4' x 8' No-Groove Textured Strand Panel Siding in 'Mist Grey' by LP Smartside.
X 3	Indicates 3/8" x 5 1/2" pre-finished lap siding, borate-impregnated wood fibre substrate with resin binding. (13 mm x 140 mm) Exterior Wood Trim in 'Commercial Brown' by KAYCAN Naturetech.
X4	Indicates 3/8" x 6" pre-finished lap siding, borate-impregnated wood fibre substrate with resin binding. WTB346121340 (13 mm x 140mm) ExteriorWood Trim in 'Red Wine' or 'Country Red' by KAYCAN Naturetech.

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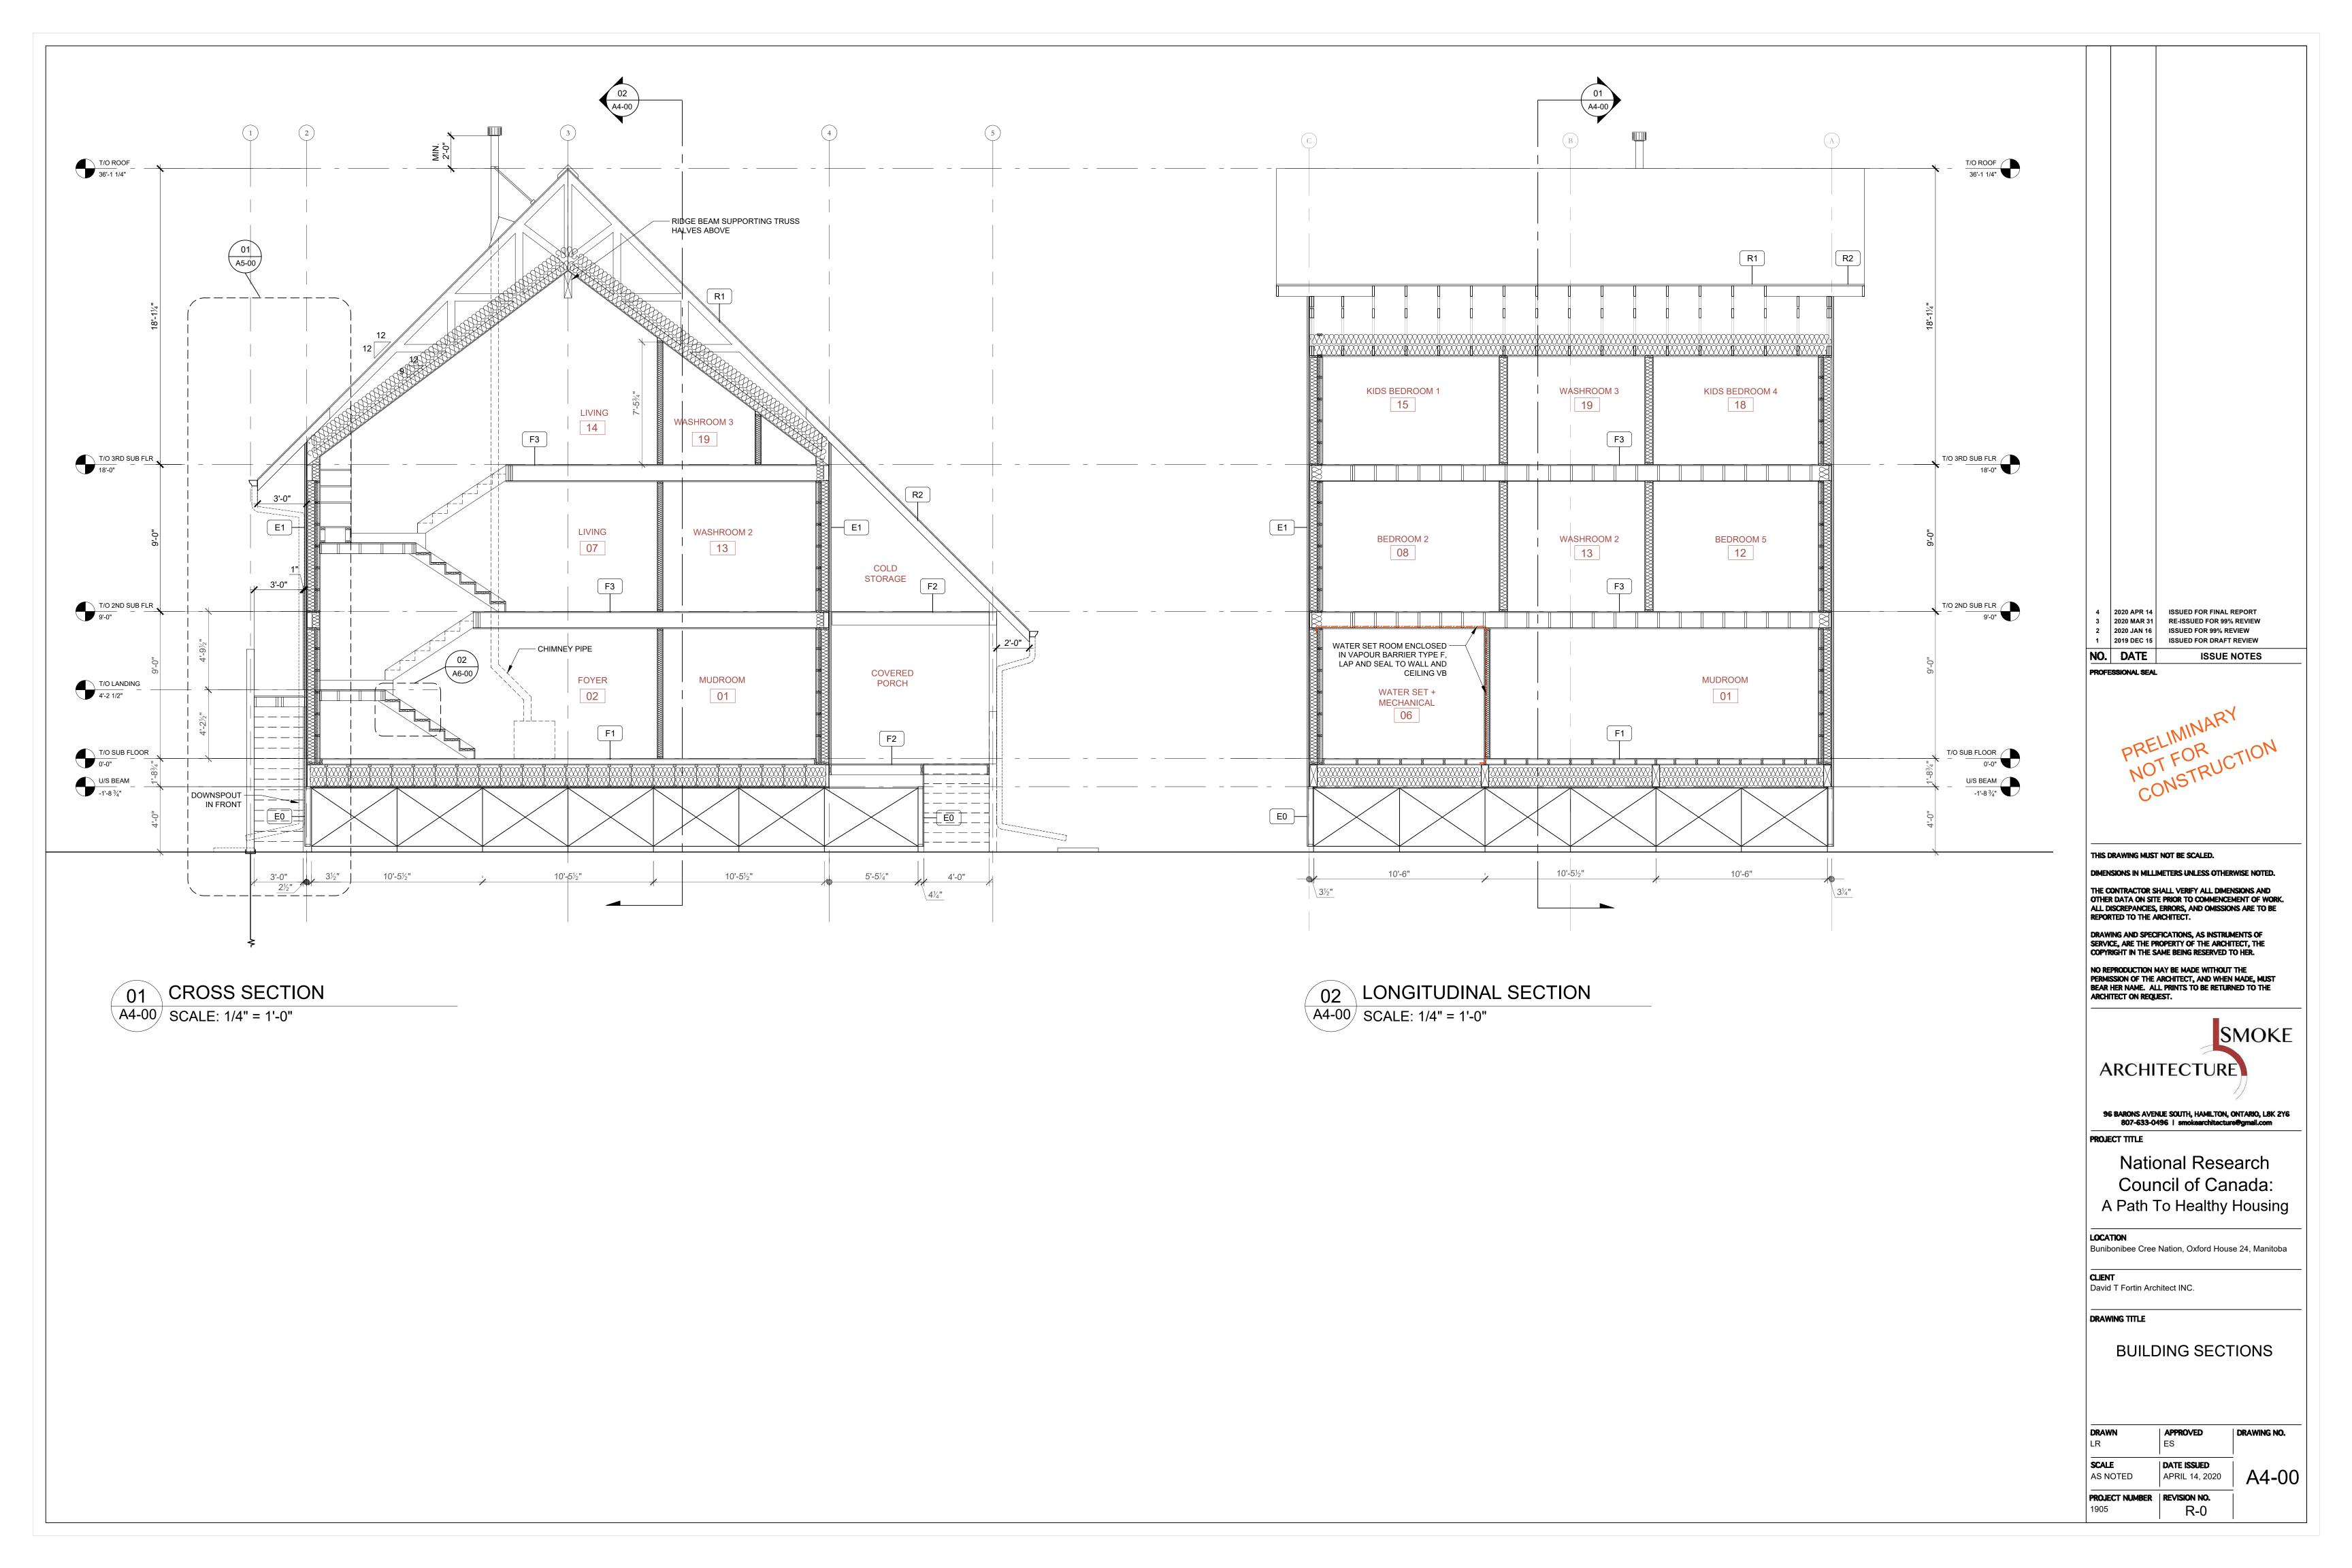
			DOOR F	PANEL	DOOR FRAME				
QTY	NO.	DOOR SIZE	TYPE	MATERIAL	MATERIAL	REMARKS			
2	D1	3'-0"x6'-8"x1 3/4"	А	INSUL. FIBERGLASS	THERMALLY BROKEN FIBERGLASS FRAME	SINGLE CYLINDER DEADBOLT, PASSAGE LOCKSET LEVER HANDLE, WEATHERSTRIPPING, LAMINATED GLASS			
1	D2	2'-8"x6'-8"x1 3/4"	В	INSUL. FIBERGLASS	THERMALLY BROKEN FIBERGLASS FRAME	SINGLE CYLINDER DEADBOLT, PASSAGE LOCKSET LEVER HANDLE, WEATHERSTRIPPING, LAMINATED GLASS			
4	D3	3'-0"x6'-8"x1 3/4"	С	SOLID CORE WOOD	WOOD	PRIVACY LOCKSET LEVER HANDLE, DOOR STOP, BIRCH VENEER DOOR c/w CLEAR FINISH			
7	D4	2'-6"x6'-8"x1 3/4"	D	SOLID CORE WOOD	WOOD	PRIVACY LOCKSET LEVER HANDLE, DOOR STOP, BIRCH VENEER DOOR c/w CLEAR FINISH			
2	D5	2'-4"x6'-8"x1 3/4"	E	SOLID CORE WOOD	WOOD	PRIVACY LOCKSET LEVER HANDLE, DOOR STOP, BIRCH VENEER DOOR c/w CLEAR FINISH			
6	D6	(3) 1'-9"x6'-8"x 3/4"	F	LAMINATED SPF PANEL	WOOD	CLEAR COATED, EXPOSED HARDWARE, METAL TRACK			
DOO USE P	OR EL	EVATION 1/4'=1'-0 GE LOCKSET LEVER HA	" NDLE FC	R LAUNDRY ROOM					
DOO USE P	OR EL	EVATION 1/4'=1'-0 GE LOCKSET LEVER HA	" NDLE FC	R LAUNDRY ROOM					
USE P	PR EL PASSAC PE A 3'-0"	EVATION 1/4'=1'-C GE LOCKSET LEVER HA	NDLE FC	R LAUNDRY ROOM TYPE C	TYPE D	TYPE E TYPE F 5'-0" 1'-9" 1'-9" 1'-9"			


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NOTE 1 Downspout c/w 48" kick to precast concrete splashpad.	
NOTE 2 Chimney c/w louvered vent cap, snow defelector and metal strap roof anchors. Extend chimney pipe to minimum 24" hig (600mm) than roof peak.	jher

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LOCA Bunib		Nation, Oxford Hous	e 24, Manitoba
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		TH AND W EXTERIOR LEVATION	
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ACOUSTICAL BATT INSULATION BEHIND PINEBOARD SOFFIT @ UNDERSIDE OF INTERIOR STAIRS (TYP.) 02 TYPICAL INTERIOR/EXTERIOR STAIR SECTION
A6-00 SCALE: 1 1/2" = 1'-0"

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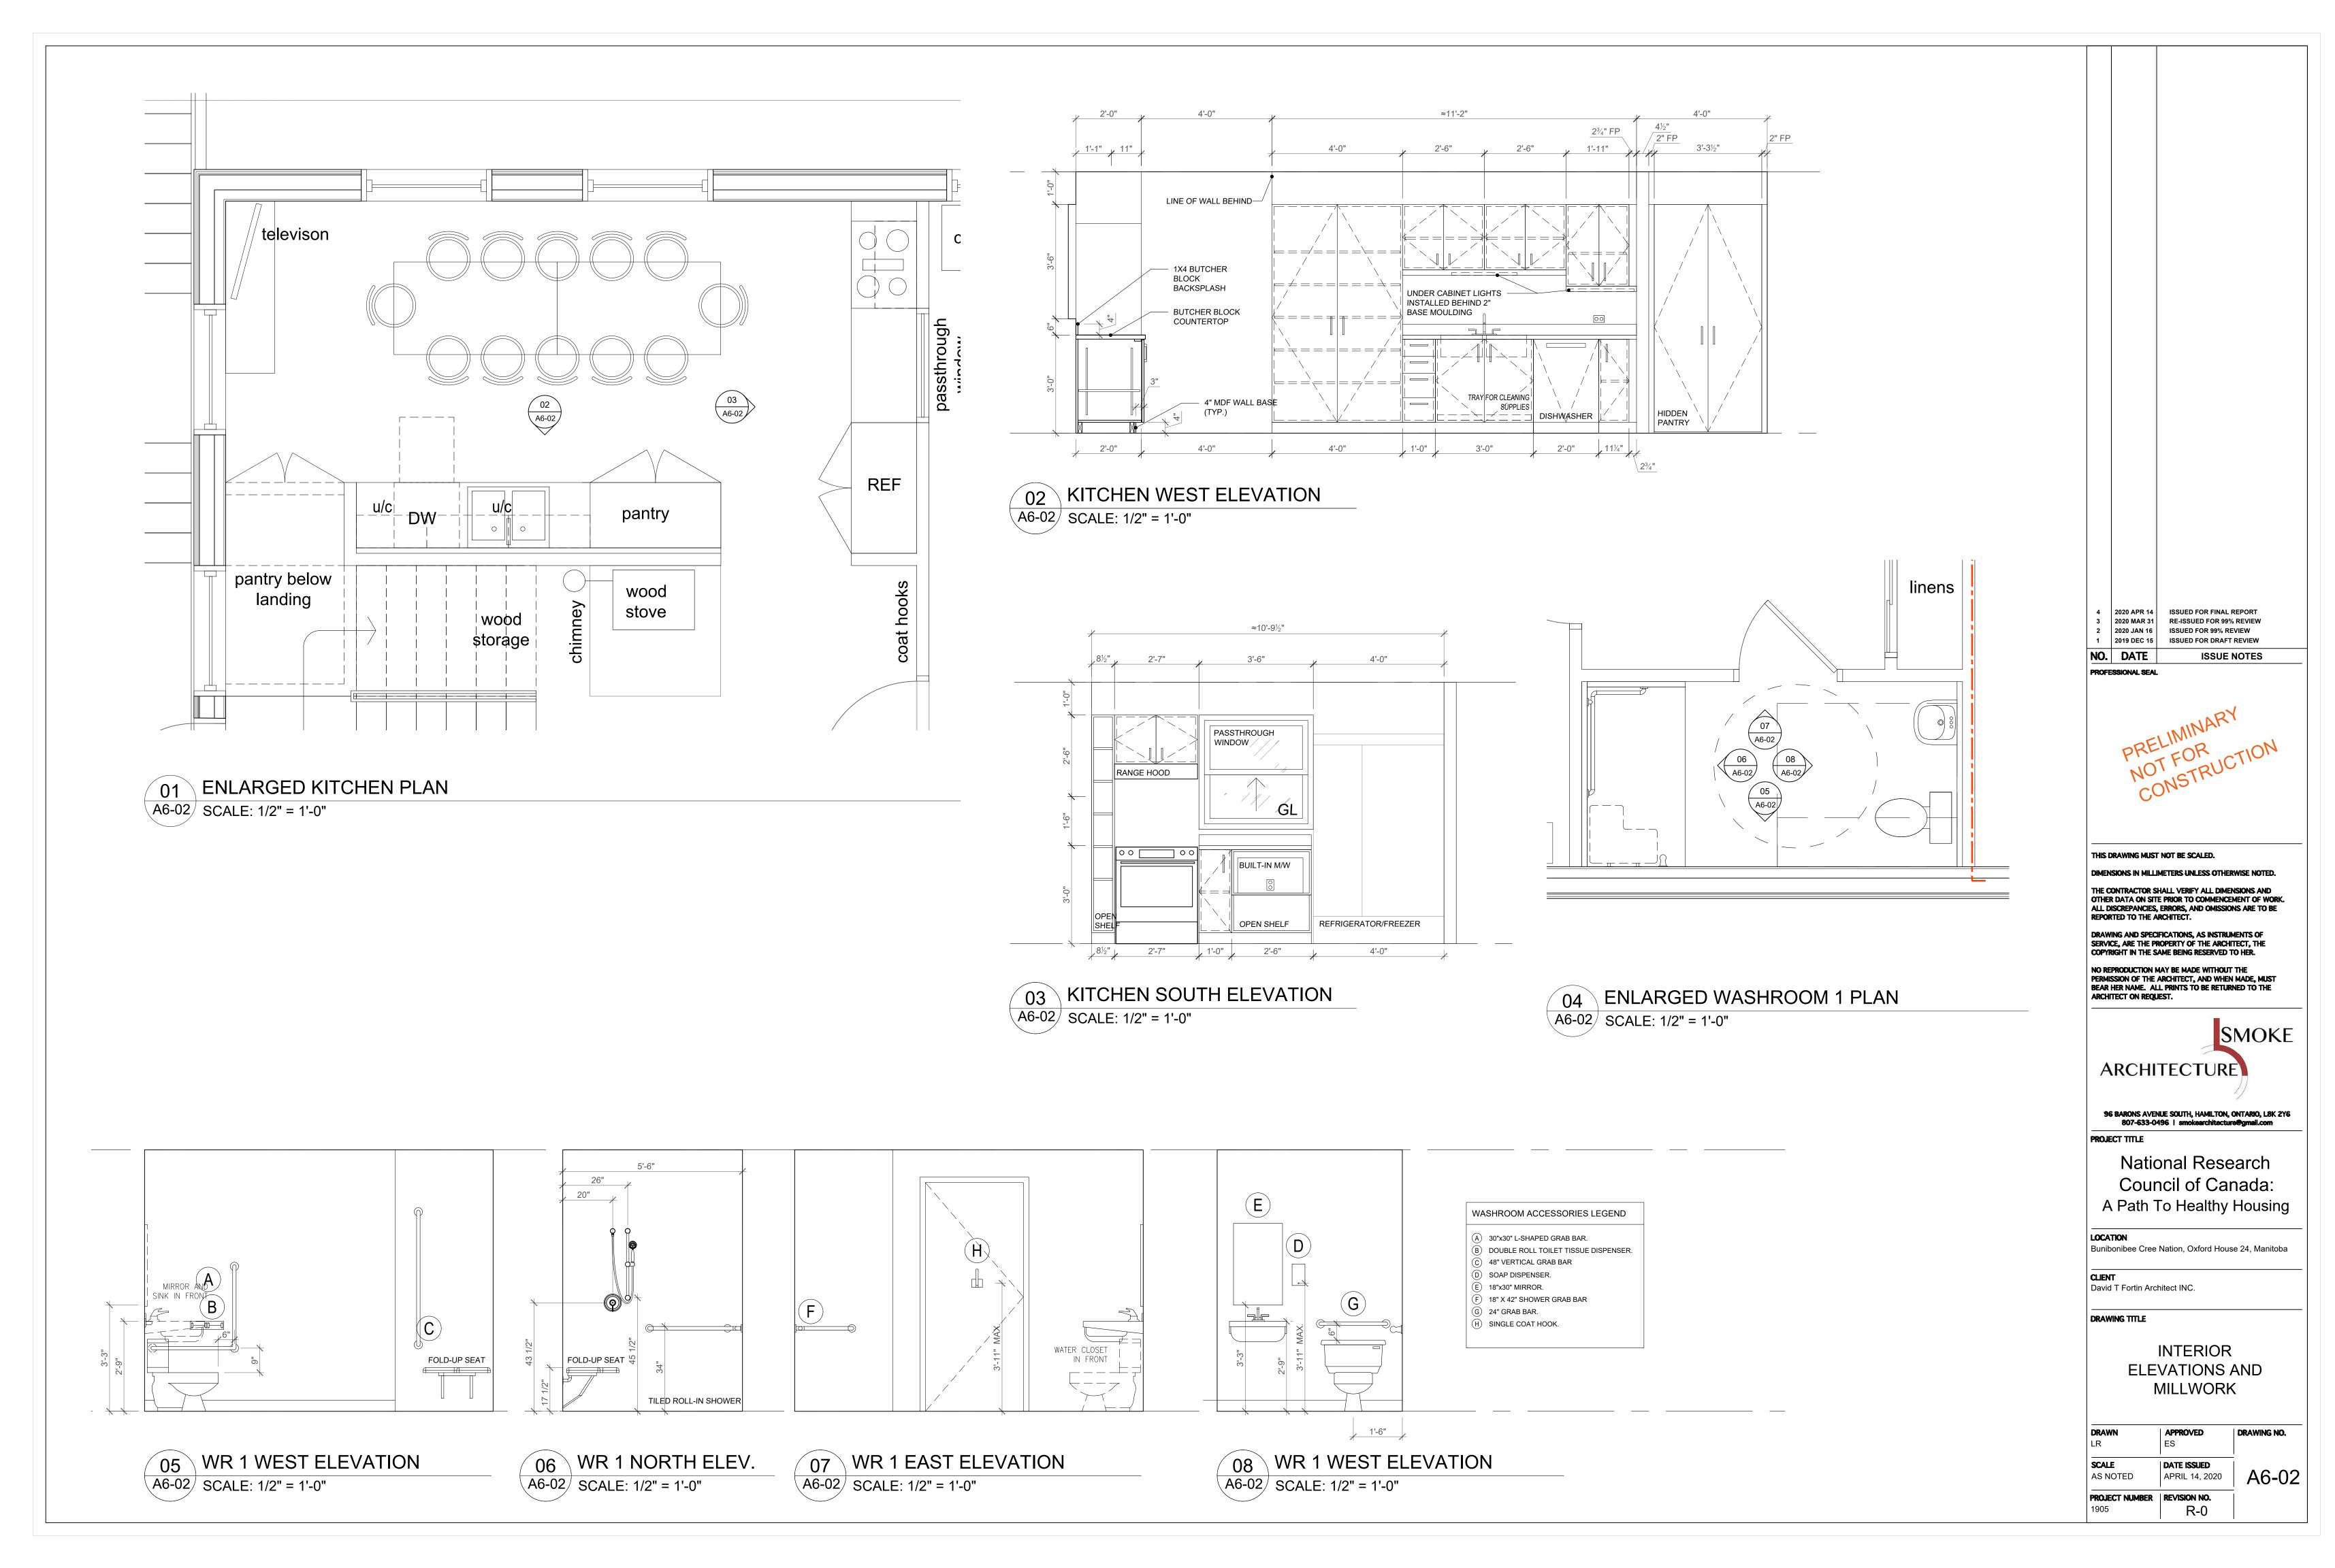
LOCATION Bunibonibee Cree Nation, Oxford House 24, Manitoba


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DRAWING TITLE

STAIR PLAN AND **DETAILS**

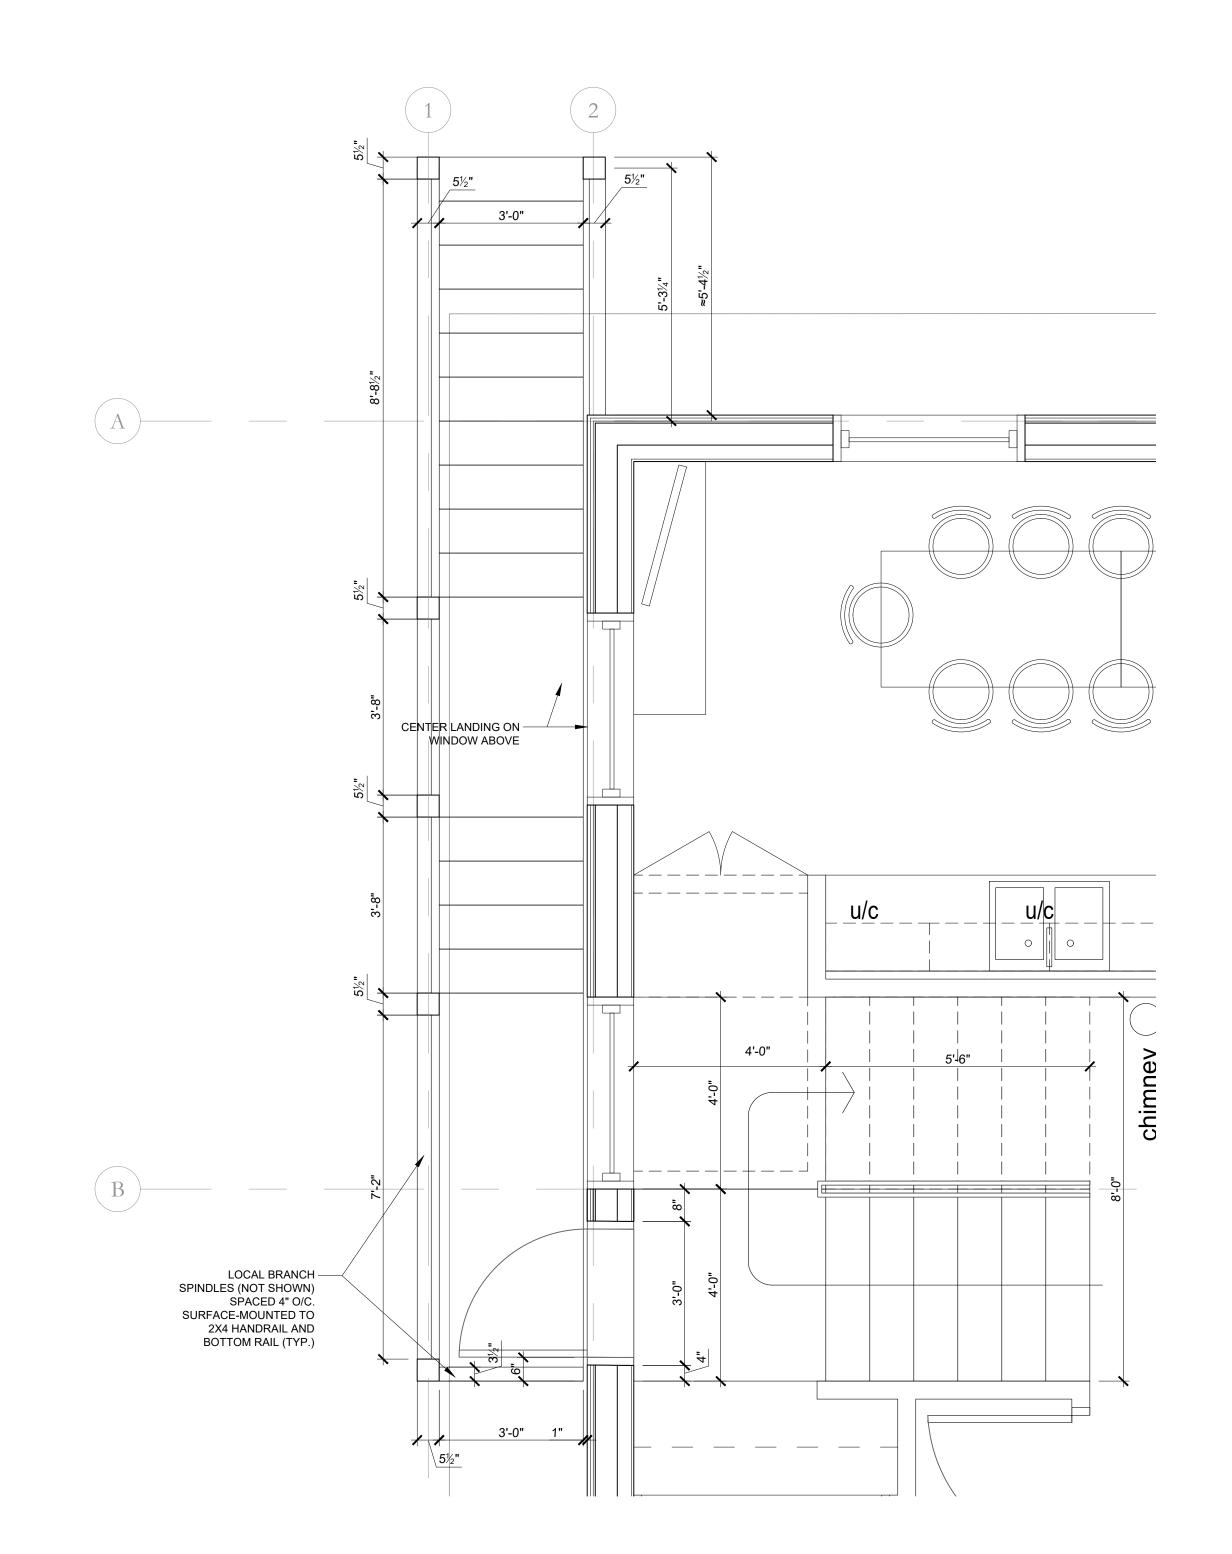
DRAWN LR	APPROVED ES	DRAWING NO.
SCALE AS NOTED	DATE ISSUED APRIL 14, 2020	A6-00
PROJECT NUMBER 1905	REVISION NO.	_



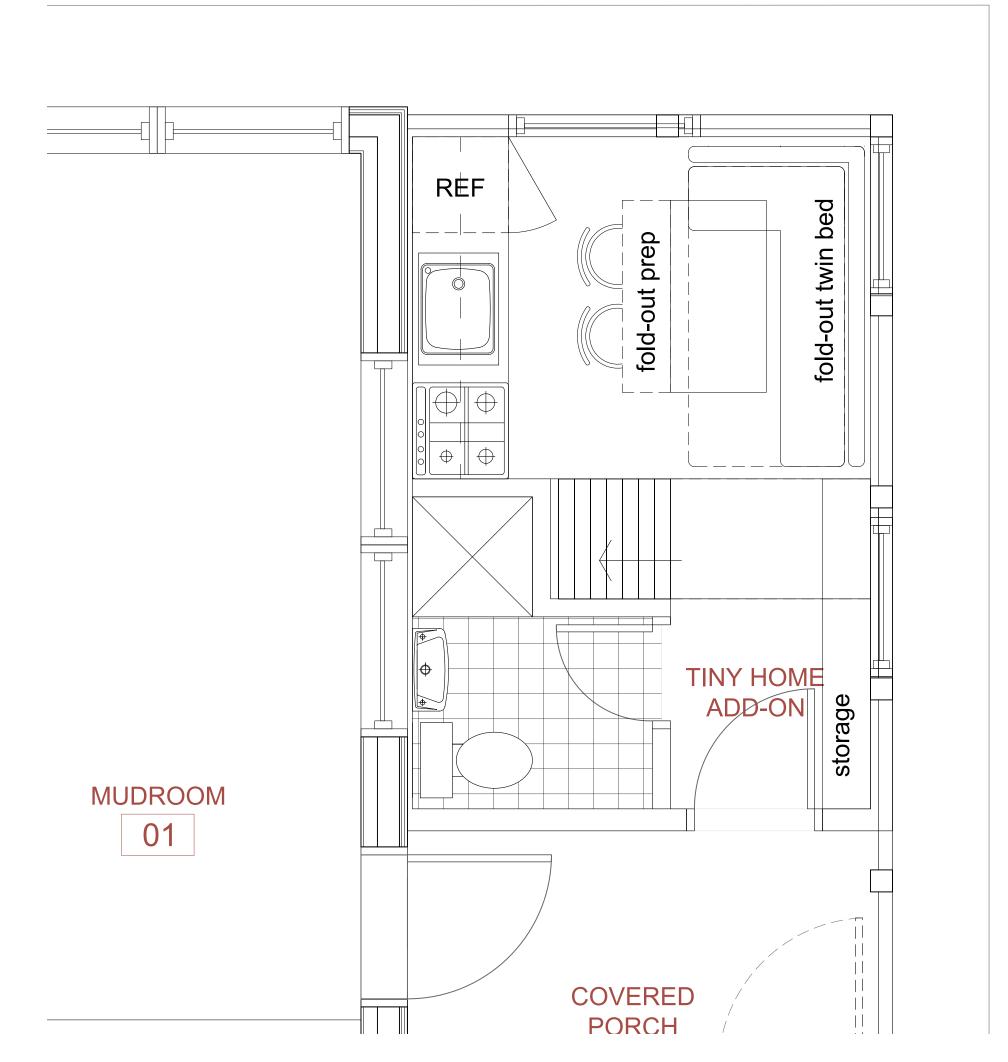

01 ENLARGED 'TINY HOME' MAIN FLOOR PLAN A6-03 SCALE: 1/2" = 1'-0"

TINY HOME NOTES "Tiny home" drawings shown above are diagrammatic ONLY. Exact details and construction assemblies TBD at

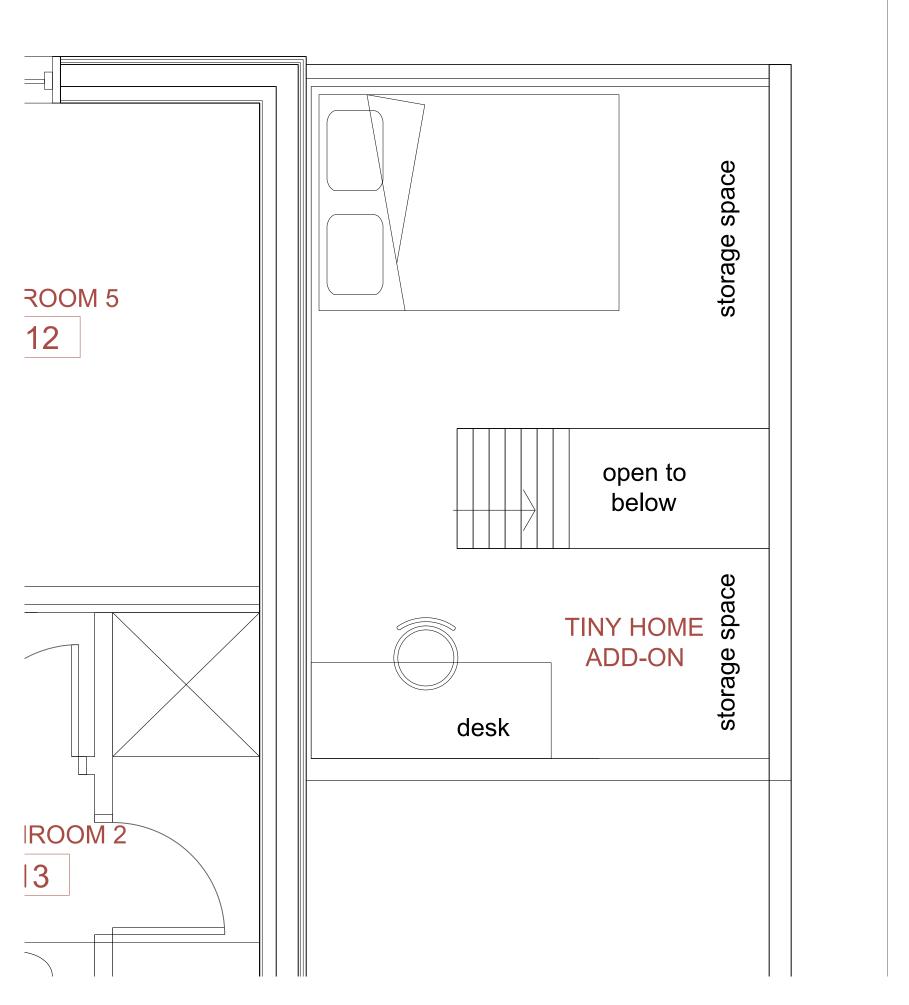

02 ENLARGED 'TINY HOME' SECOND FLOOR PLAN A6-03 SCALE: 1/2" = 1'-0"

4 2020 APR 14 ISSUED FOR FINAL REPORT
3 2020 MAR 31 RE-ISSUED FOR 99% REVIEW
2 2020 JAN 16 ISSUED FOR 99% REVIEW
1 2019 DEC 15 ISSUED FOR DRAFT REVIEW

ISSUE NOTES

NO. DATE

THIS DRAWING MUST NOT BE SCALED.

DIMENSIONS IN MILLIMETERS UNLESS OTHERWISE NOTED. THE CONTRACTOR SHALL VERIFY ALL DIMENSIONS AND OTHER DATA ON SITE PRIOR TO COMMENCEMENT OF WORK.
ALL DISCREPANCIES, ERRORS, AND OMISSIONS ARE TO BE

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ARCHITECTURE

SMOKE

96 BARONS AVENUE SOUTH, HAMILTON, ONTARIO, L8K 2Y6 807-633-0496 | smokearchitecture@gmail.com

National Research Council of Canada: A Path To Healthy Housing

Bunibonibee Cree Nation, Oxford House 24, Manitoba

David T Fortin Architect INC.


DRAWING TITLE

OPTIONAL 'TINY HOME' **ADDITION PLANS**

APPROVED DRAWING NO. DATE ISSUED A6-03 APRIL 14, 2020 AS NOTED PROJECT NUMBER | REVISION NO. R-0



APPENDIX B
ENGAGEMENT SESSION 1 BOARDS

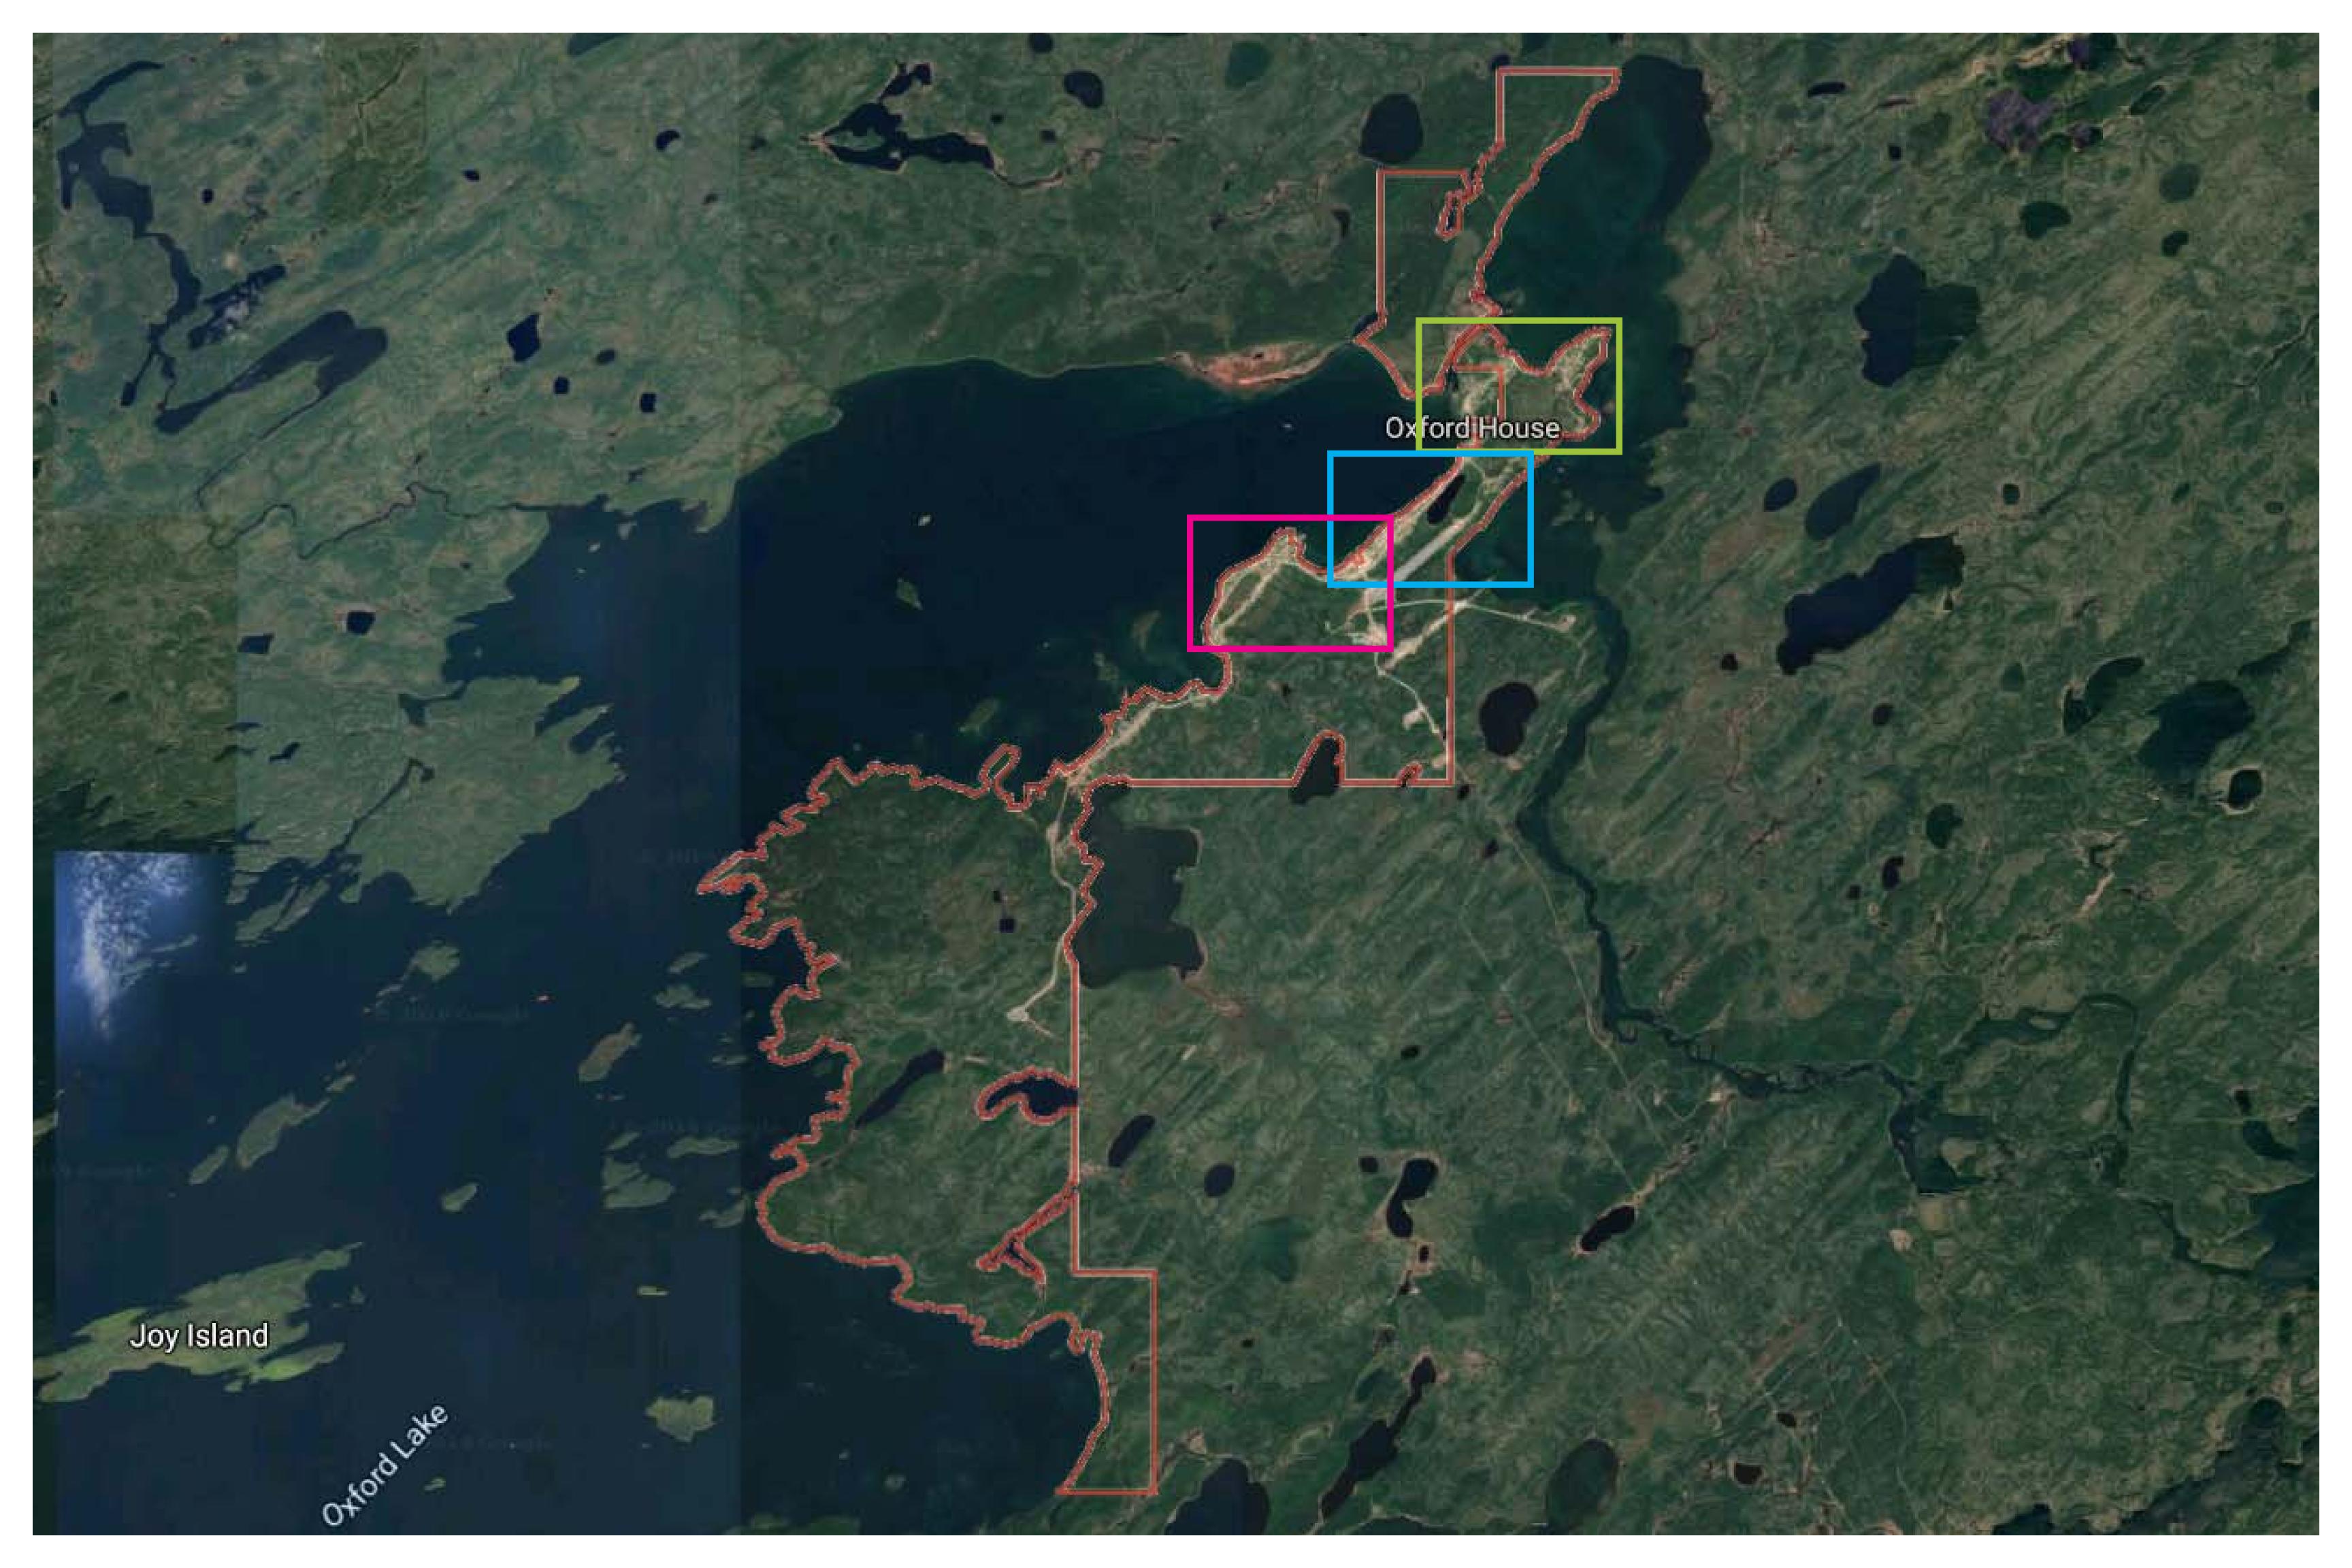










WHAT WOULD MAKE THE BEST HOUSE FOR BUNIBONIBEE MEMBERS? Put stickers on ideas/images you like best and add comments on what's missing



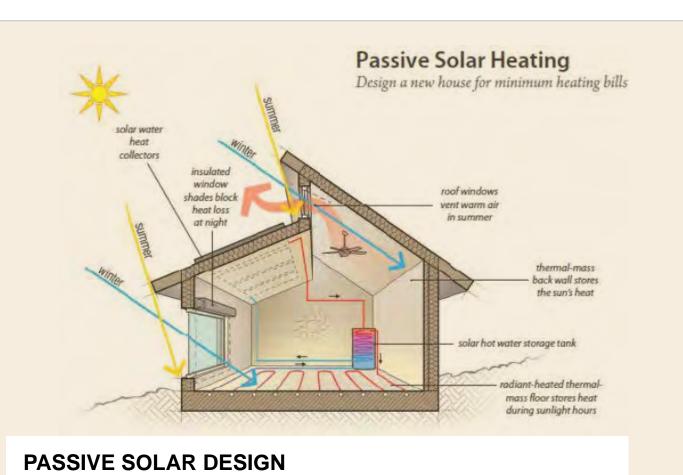

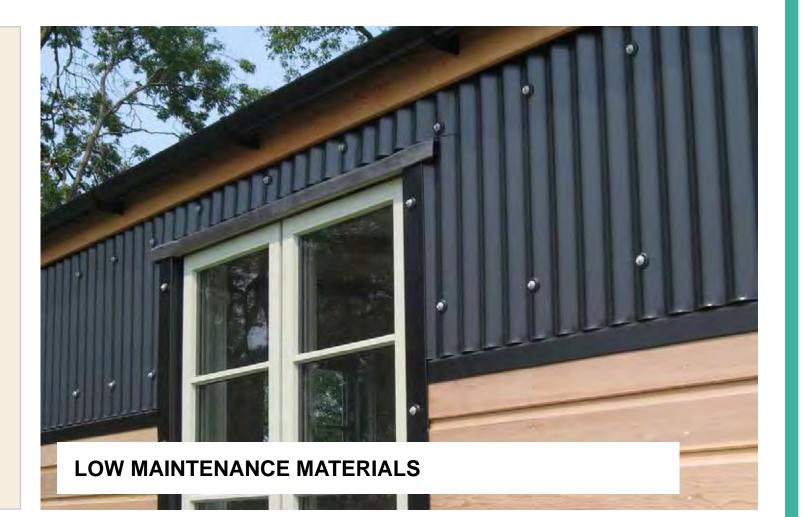



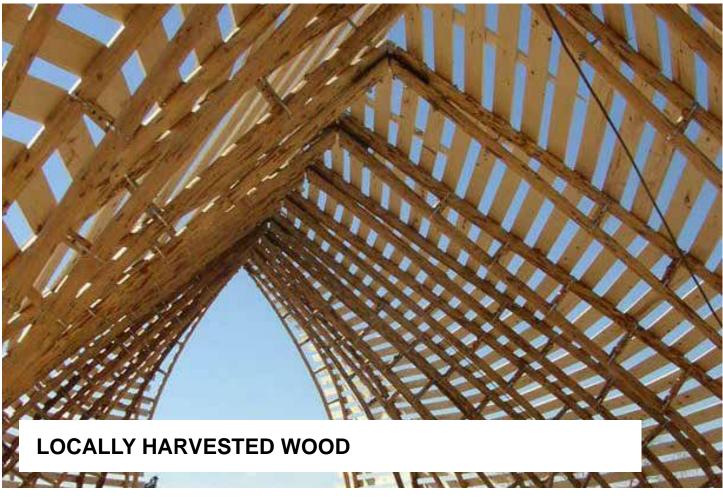











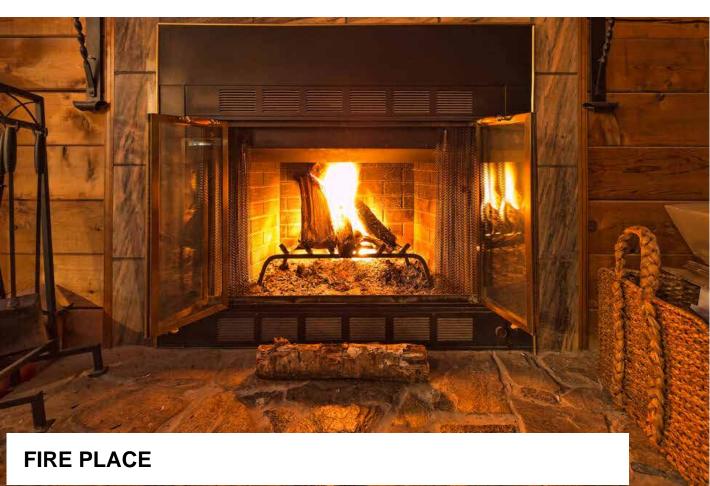

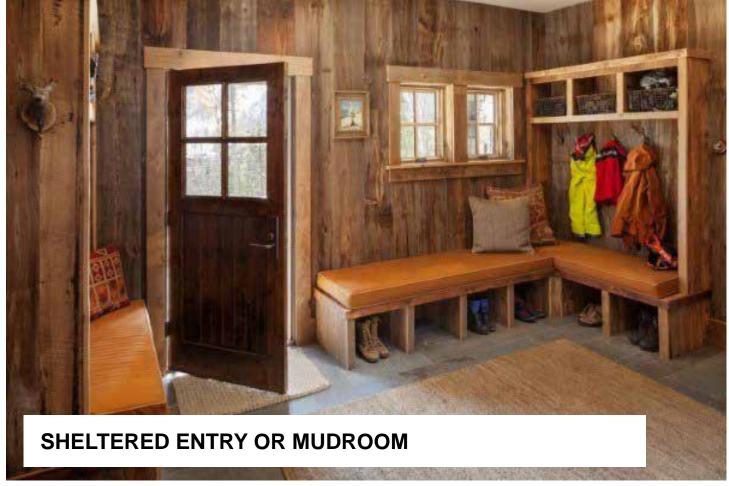




WHAT'S MISSING?

"The challenge of this project is that it is simply not possible to solve the housing crisis on Indigenous lands with a single design," - Manitoba Mini Homes


"Each community is unique and will need to tailor and/or modify their own designs to meet their unique challenges."

WHAT SHOULD THE INTERIORS BE LIKE?

Put stickers on ideas/images you like best and add comments on what's missing

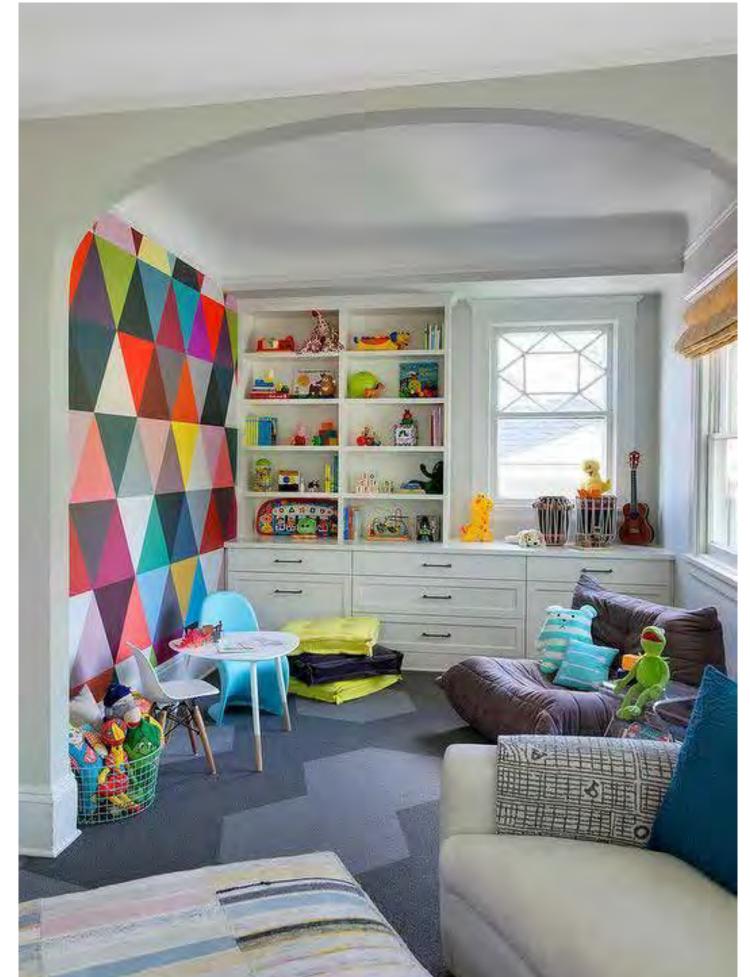



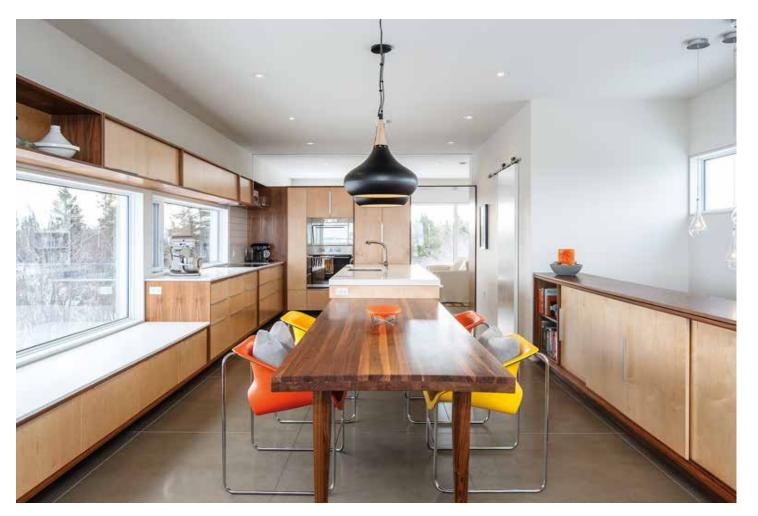















WHAT'S MISSING?




APPENDIX C ENGAGEMENT SESSION 2 BOARDS


HOUSE OPTIONS

HOUSE SIZE

OPTION 1A: 2.5 storey (9 bedrm) 2.5 storey + tiny home **OPTION 1B:**

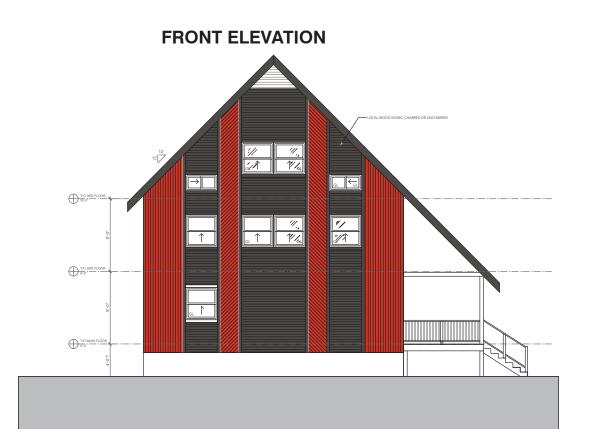

2.5 STOREY HOUSE OPTION

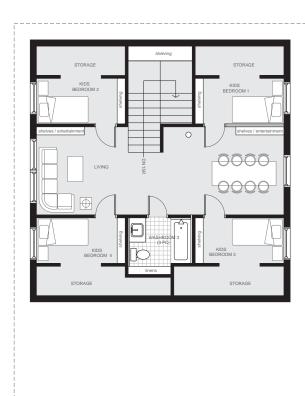

UPPER FLOOR




SECOND FLOOR



1.5 storey (5 bedrm) **OPTION 2A:** 1.5 storey + tiny home **OPTION 2B:**

FRONT ELEVATION

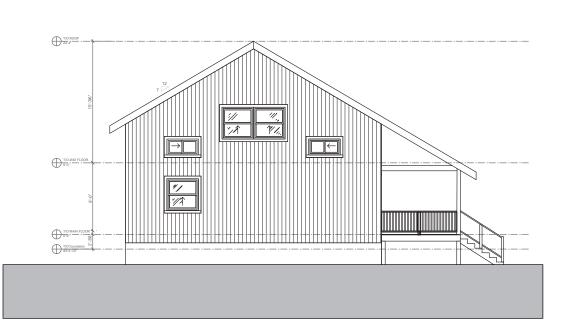


1.5 STOREY HOUSE OPTION




UPPER FLOOR



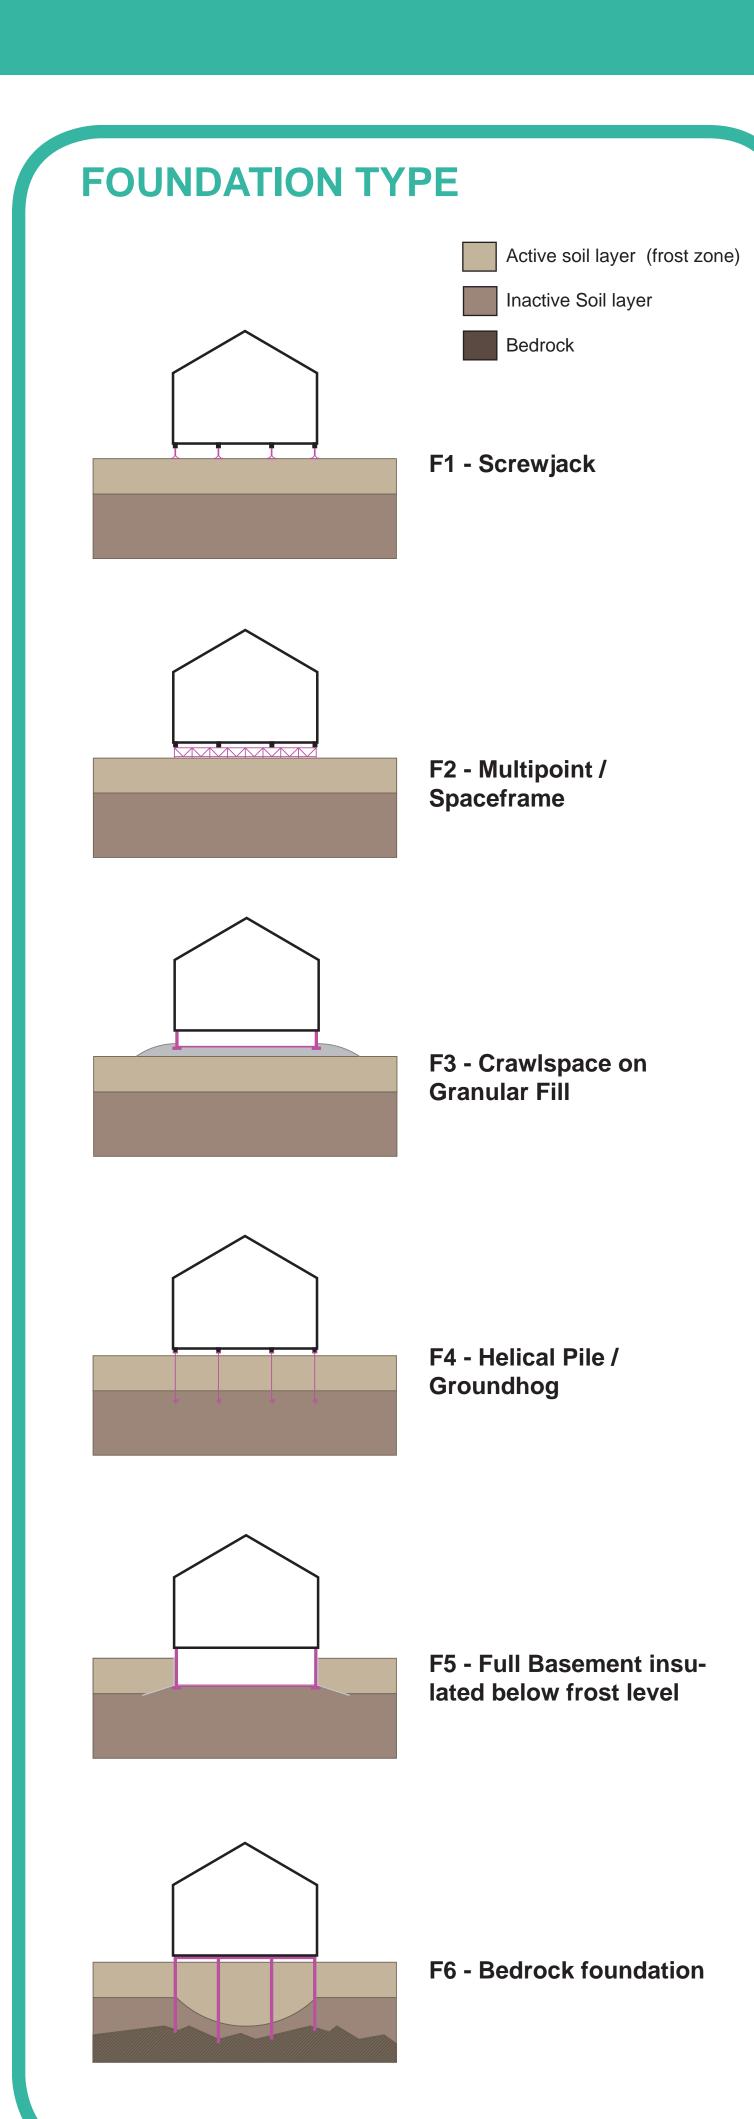

WALL TYPE

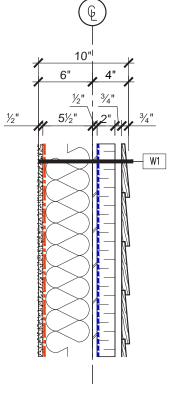


W1 - 2x6 Wood Stud Walls + **Rigid Insulation**

- 1/2" impact-resistant GWB (abuseboard), paint finish Smart vapour retarder (MemBrain or approved equal)

 2x6" Stud framing @ 16" o.c. or 24" o.c. as per
 structural filled with R-22 batt insulation
- 1/2" OSB sheathing
 Spun bonded polyolefin (house wrap)
 2" rigid insulation: extruded polystyrene


- 3/4" strappingPre-finished engineered wood siding

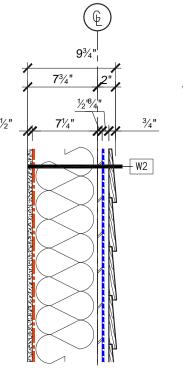

W2 - 2x8 Wood Stud Walls


- 1/2" impact-resistant GWB (abuseboard), paint finishSmart vapour retarder (MemBrain or approved equal) structural filled with R-22 batt insulation
- 1/2" OSB sheathing Spun bonded polyolefin (house wrap)


- 3/4" strapping
- Pre-finished engineered wood siding

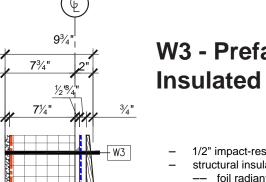

W3 - Prefab Structurally **Insulated Panels (SIP)**

- 1/2" impact-resistant GWB (abuseboard), paint finishstructural insulated panel (SIP)
- foil radiant vapour retarder
 foamed-in-place 2x8" stud framing @ 16" o.c. or 24" o.c. as per structural filled with closed cell polyurethane foam
- Spun bonded polyolefin (house wrap)
- 3/4" strapping
 Pre-finished engineered wood siding

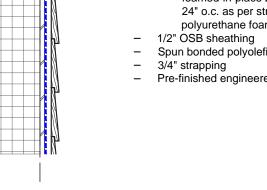

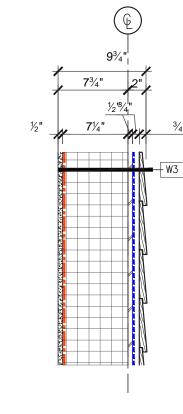

NEIGHBOURHOOD CONCEPTS

